

REDMOND WESTSIDE PARK RENOVATION

PROJECT ADDRESS 5810 156TH AVE NE REDMOND. WA 98052

PARCEL NUMBER: 1425059039

SITE PLAN ENTITLEMENT Project # 50021924

LEGAL DESCRIPTION:

S 1/2 OF N 1/2 OF NW 1/4 OF NE 1/4 LESS POR ELY OF LN BEG AT PT ON N LN SUBDIV 176.8 FT W OF NE COR TH BEARING S 63-38-00 W 483.6 FT TH SWLY TO PT ON S LN THOF 670.3 FT W OF E LN

SECTION, TOWNSHIP, RANGE: NE-14-25-5

279,655 SF / 6.42 ACRES

SHEET INDEX

CITY OF REDMOND - NOT TO SCALE

VICINITY MAP

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COMPOSITE PLAN SET

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PLAN SET

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7.	2 OF 2	SURVEY
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35.	E3.1A	PHOTOMETRIC PLAN

PROJECT DATA

PARCEL AREA

LIMIT OF WORK AREA ZONING NEIGHBORHOOD	90,368 SF / 2.07 ACRES R-5 OVERLAKE	S DISTURBED
NEIGHBORHOOD	O V EI (E) (I (E)	
	REQUIREMENT	PROPOSED
SETBACKS - FRONT	 15'-0"	 15'-0"
SIDE	5'-0"	5'-0"
OPEN SPACE	20%	100%
LOT COVERAGE	40%	0.6%
BUILDING HEIGHT	35'-0"	14'-2"
BUILDING TYPE		IBC TYPE VB
PARKING	0, ADEQUATE FOR PEAK USE	10 (INCLUDES 1 VAN ACCESSIBLE SPACE) 2 BIKE RACKS
		Z DINE RAUNS

WATER QUALITY FACILITY - NOT APPLICABLE, SEE STORMWATER REPORT WATER QUANTITY FACILITY - NOT APPLICABLE, SEE STORMWATE REPORT

IMPERVIOUS SURFACE AREA								
EXISTING		PROPOSED IMPERVIOUS SURFACE		TOTAL SITE AREA	MAXIMUM IMPERVIOUS SURFACE (CODE CITATION)			
7, 124 51 / 0.10		IMPERVIOUS SURFACE AREA (SF)	16,399 SF / 0.37 ACRES					
IMPERVIOUS SURFACE (%) 3%		IMPERVIOUS SURFACE (%)	6%	279,655 SF / 6.42 ACRES	60%			

TECHNIQUE	How Technique achieved	POINTS AWARDED - OVERLAKE VILLAGE
1. 25% of the plants installed are Northwest adaptive and 25% of the plants installed are native.*	Total plants installed: 1,343 Total plants NW adaptive: 7 (0.5%) Total plants native: 1,336 (99%)	5 POINTS
2. 40% of existing significant trees, including landmark trees, are retained.	Retained (no impacts): 44%	3 POINTS
3. Minimum of 25% of proposed trees are evergreens.	Proposed Trees: 80, Proposed Evergreen Trees: 30 (38%)	3 POINTS
6. 10% increase over the minimum number of required replacement trees, street trees, or parking lot trees.*	Minimum number of required replacement trees: 35 Proposed replacement Trees: 39 (10%)	3 POINTS
10. Minimum of 25% of landscaped areas are designed with landscaping that does not require irrigation after a three-year period.	Total Landscaped Area: +/- 30,000 SF Temporary irrigation area: 20,000 SF (67%)	3 POINTS
11. Minimum of 50% of landscaped areas where native soils are preserved on-site.	Landscape Areas native soil preserved: 30,000 SF	4 POINTS
	TOTAL	21 POINTS

Tree Retention Table*				·
Tree Type	Removal	Impacted	Retained	Total
Landmark	0	2	1	3
(>30")	0%	3%	2%	5%
Significant	0	33	27	60
(6 " – 30")	0%	52%	43%	95%
Totala	0	35	28	63
Totals -	0%	56%	44%	100%
Replacement Trees	0	35	N/A	35
*See Arborist Report – Tree Inventory a	nd Health Assessment Table and n	nap for detailed tree information.		

PROJECT TEAM

Owner:

City of Redmond

Project Manager: Rob Crittenden 425-556-2838 rcrittenden@redmond.gov

Project Design Team:

Board & Vellum (Landscape Architecture, Arborist)

Primary Contact: Leslie Batten, PLA 206-707-8895 x127 115 15TH Ave E, Suite 100, Seattle, WA 98112 leslie@boardandvellum.com

Core Design (Surveyor)

Primary Contact: Glenn Sprague 425-885-7877 12100 NE 195th St, Suite 300, Bothell, WA 98011 gxs@coredesigninc.com

Mayfly Engineering & Design (Civil)

Primary Contact: Robin Thaler P.E. 206-935-5356 5042 49TH Ave SW, Seattle, WA 98136 robin@mayflyeng.com

Associated Earth Sciences Inc (Geotechnical)

Primary Contact: Jennifer Saltonstall, L.G., L.Hg. 425-827-7701 911 5th Ave, Seattle, WA 98033 jsaltonstall@aesgeo.com

Raedeke Associates (Environmental)

Primary Contact: Kolten Kosters, MS, PWS 206-525-8122 2111 N Northgate Way, Suite 219, Seattle, WA 98133 KKosters@raedeke.com

Big 3 Design (MEP)

Primary Contact: Ed Borden III, P.E., 832-541-8769 eborden@bigthreemep.com


Approved for Construction

Steve Flude, P.E.

THIS DEVELOPMENT SHALL BE CONSTRUCTED IN ACCORDANCE WITH THE 2020 CITY OF REDMOND STANDARD SPECIFICATIONS AND

DATE

⁄ellur Board

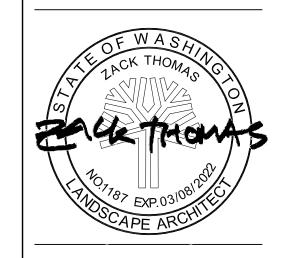



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REVISIONS

ISSUANCES

DATE DESCRIPTION 02.26.2020 30% PLANS 04.20.2020 60% PLANS

04.30.2020 SITE PLAN ENTITLEMENT

COPYRIGHT BOARD AND VELLUM LLC. ALL RIGHTS RESERVED. ORIGINAL SHEET SIZE IS 22"x34"

BOARD & VELLUM PROJECT #: 2019176.00 500021924 PROJECT #: PLOT DATE: 04.30.2020

COVER SHEET G1.0

1 of 35

ABI	BREVIATIONS				
Aban	Abandon(ed)	Gal	Gallon	Qty	Quantity
Asph ABW ATB ACV AVB	Adjust Americans with Disabilities Act Aerial Interconnect Aluminum Angle Point Approximate Asphalt Asphalt Bike Way Asphalt Treated Base Automatic Control Valve Automatic Vacumn Breaker	GPM Galv GIP GSP GM G Reg Gas V Gr Gnd GP	Gallons Per Minute Galvanize/Galvanized Galvanized Iron Pipe Galvanized Steel Pipe Gas Meter Gas Regulator Gas Valve Grade Ground Guy Pole	R RR Rlwy Reconn Red Ref Reinf RCP Reloc	Reducer Refer/Reference Reinforcing/Reinforcemer Reinforced Concrete Pipe Relocate Remove
Ave Avg BV BOC BO BF Br Blkhd BfV	Avenue Average Ball Valve Beginning of Curb Blow Off Bottom Face Brick Bulkhead Butterfly Valve Cable	HH HPG HPS Horiz HB HC Hse Hyd	Handhole High Pressure Gas High Pressure Sodium Horizontal Hose Bib Hose Connection House Hydrant Inch/Inches Inlet	R&R Repl Req'd Ret Rt R/W RGS RS Rdwy RD	Remove and Replace Replace Required Retire(d) Right Right of Way Rigid Galvanized Steel Rigid Steel Roadway Roof Drain
Cal CIP CB CL C CLF Ch CO Clr Conw CC CO	Caliper Cast Iron Pipe Catch Basin Center Line Center to Center Chain Link Fence Chamber Class Clean Out Clearance Concrete Concrete Bike Way Concrete Culvert Condition Conduit Connect Corrugated Metal Pipe Continuous Cross Cubic Feet Cubic Yard Culvert Curb and Gutter Curb Radius Department Diameter Direct Burial Cable District Gate Valve Double Check Valve Driveway Ductile Iron Pipe	ID IE Inv IP Irrg IRC Irrg IH Jt JB	Inside Diameter Invert Elevation Invert (Line) Iron Pipe Irrigation Irrigation Controller Irrigation Irrigation Head Joint Junction Box Kilovolt Large Inlet Top Left Light Pole Lineal Feet Location/Locate Manhole Manual Control Valve Manual Drain Valve Maximum Mechanical Joint Mercury Vapor Light Miniumum Miscellaneous Monument Line Not In Contract Not To Scale Number On Center Outside Diameter	SB SCL SEND SGD Sht SSS Spec Sht SSS Spec Stl P Sth Shruct Struct TC THE STRUCT THE STRU	Sand Box Seattle City Light Seattle Engineering Dept Seattle Water Departmen Subgrade Service Drain Sheet Side Sewer — Combined Side Sewer — Sanitary Sleeve Spaces Specification(s) Sprinkler Head Square Standard Steel Steel Pipe Street Street Designation Sign Street Light Handhole Street Name Sign Structural/Structure Survey Line Tee Telephone Telephone Cable Telephone Conduit Top of Curb Telephone Handhole Television Cable Television Handhole Temporary Testhole
Ea Esmt Ecc Elec ECb ECd ED EMH EV EI Elev Encl EOC Eq Ex Exp	Each Easement Eccentric Electric/Electrical Electric Cable Electric Duct Electric Manhole Electric Vault Elevation Elevation Enclosure End of Curb Equal Existing Expansion	Pav PPB PDP PS PSD PSDD PE PL PCC PC PI PRC PT PVC LBS	Pavement Pedestrian Push Button Perforated Drain Pipe Pipe Sewer Combined Pipe Sewer Sanitary Pipe Storm Drain Pipe Storm Drain Detention Plain End Plate Point of Compound Curvature Point of Curvature Point of Intersection Point of Reverse Curve Point of Tangency Polyvinyl Chloride Pounds Pounds	TF Tr TrCb TrCd TCHH TrSB TrSP XP Typ VCh V/Var Vert VB V/C	Top Face Traffic Traffic Cable Traffic Conduit Traffic Handhole Traffic Signal Box Traffic Signal Pole Transmission Pole Typical Valve Chamber Variable Vertical Valve Box Vertical Curve

Pounds per Square Inch

Pressure Reducing Valve

Pressure Vacumn Breaker

Power Pole with Light

Power Pole

Property Line

PP

PPL PRV

PVB

PL Property Li Prop Proposed

FLP

Fig FF

FG

FS FM

Field Light Pole

Finished Floor

Finish Grade

Force Main

Finished Surface (paving)

Figure

WM

Water Meter


WCR Wheel Chair Ramp

w/ With WP Wood Pole

WSP Wood Stave Pipe

GENERAL NOTES:

- ALL WORK SHALL CONFORM WITH ALL FEDERAL, STATE, OR LOCAL LAWS, ORDINANCES AND REGULATIONS THAT AFFECT WORK UNDER THE CONTRACT. SEE SPECIFICATIONS FOR ADDITIONAL DETAILS
- A COPY OF THE APPROVED CONTRACT DOCUMENTS SHALL BE ON SITE WHENEVER CONSTRUCTION IS IN PROGRESS INCLUDING A COPY OF THE CURRENT CITY OF REDMOND STANDARD DETAILS AND SPECIFICATIONS.
- CONTRACTOR SHALL VERIFY ALL EXISTING DATA SHOWN IN THESE DOCUMENTS AND NOTIFY ARCHITECT IMMEDIATELY OF ANY CONFLICTS WITH PROPOSED FEATURES PRIOR TO CONSTRUCTION.
- DATUM PER CITY OF REDMOND. ALL UTILITIES SHOWN HAVE BEEN ESTABLISHED BY FIELD SURVEY OR AVAILABLE RECORDS AND SHOULD BE CONSIDERED APPROXIMATE ONLY AND NOT NECESSARILY COMPLETE. IT IS THE SOLE RESPONSIBILITY OF THE CONTRACTOR TO INDEPENDENTLY VERIFY THE ACCURACY OF ALL UTILITY LOCATIONS SHOWN AND TO FURTHER DISCOVER AND AVOID ANY OTHER UTILITIES NOT SHOWN ON THE PLAN WHICH MAY BE AFFECTED BY CONSTRUCTION.
- THE CONTRACTOR SHALL PROVIDE AND MAINTAIN SEDIMENTATION CONTROL AND COLLECTION FACILITIES TO PREVENT ERODED SOILS FROM ENTERING THE PUBLIC DRAINAGE SYSTEM DURING EXECUTION OF THE CONTRACT.
- KEEP ALL WALKWAYS CLEAR AND FREE OF DEBRIS. PAVED SURFACES THAT ARE DAMAGED DURING CONSTRUCTION SHALL BE REPAIRED TO THE SATISFACTION OF THE OWNER AT NO COST TO THE OWNER.
- STORAGE OF MATERIALS AND EQUIPMENT WILL BE ALLOWED ONLY IN AREAS DESIGNATED FOR CONSTRUCTION OR STORAGE. UNDER NO CIRCUMSTANCES ARE MATERIALS TO BE STORED IN PUBLIC USE AREAS OF THE PARK PROPERTY.
- ALL IMPROVEMENTS SCHEDULED TO REMAIN THAT ARE DAMAGED DURING THE COURSE OF EXECUTION OF THE CONTRACT WORK SHALL BE REPLACED BY THE CONTRACTOR TO THE ENGINEERS SPECIFICATIONS AT NO ADDED COST TO THE OWNER. THESE IMPROVEMENTS MAY INCLUDE ASPHALT AND CONCRETE PAVING, BENCHES, RAILINGS, IRRIGATION, VEGETATION, AND VARIOUS OTHER UTILITIES.
- CONTRACTOR TO MAINTAIN AN 8'-0" CORRIDOR BETWEEN 156TH ST NE TO THE BRIDLE TRAILS TRAILHEAD AT ALL TIMES DURING CONSTRUCTION.

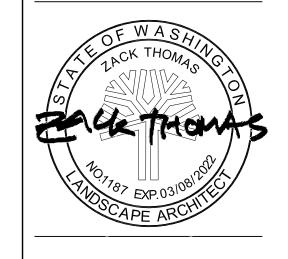



WESTSIDE | |ON

REDMOND
RENOVATI
5810 156TH AVE NE
REDMOND, WA 98052

REVISIONS DATE DESCRIPTION

ISSUANCES

DATE DESCRIPTION 02.26.2020 30% PLANS

04.20.2020 60% PLANS

04.30.2020 SITE PLAN ENTITLEMENT

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ORIGINAL SHEET SIZE IS 22"x34" BOARD & VELLUM PROJECT #: 2019176.00 500021924 PROJECT #:

PLOT DATE: 04.30.2020

SHEET:

NOTES G1.0

SHEET NO.: 2 OF **35**


Approved for Construction

Steve Flude, P.E.

DATE

THIS DEVELOPMENT SHALL BE CONSTRUCTED IN ACCORDANCE WITH THE 2020 CITY OF REDMOND STANDARD SPECIFICATIONS AND

Board & Vellun
115 15th Ave E. Suite 100 Seattle, WA 98112

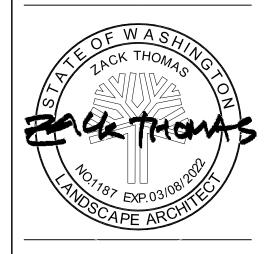



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PLOT DATE: 04.30.2020

L-100

COMPOSITE SITE PLAN

SHEET NO.: 3 OF **35**

THIS DEVELOPMENT SHALL BE CONSTRUCTED IN ACCORDANCE WITH THE 2020 CITY OF REDMOND STANDARD SPECIFICATIONS AND DETAILS.

ard & Vellun 15 15th Ave E. Suite 100 Seattle, WA 98112





IOND WESTSIDE PARK
VATION

5810 156TI REDMOND, OWNER:

DESCRIPTION

04.30.2020

REVISIONS DATE

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PLOT DATE:

SHEET:

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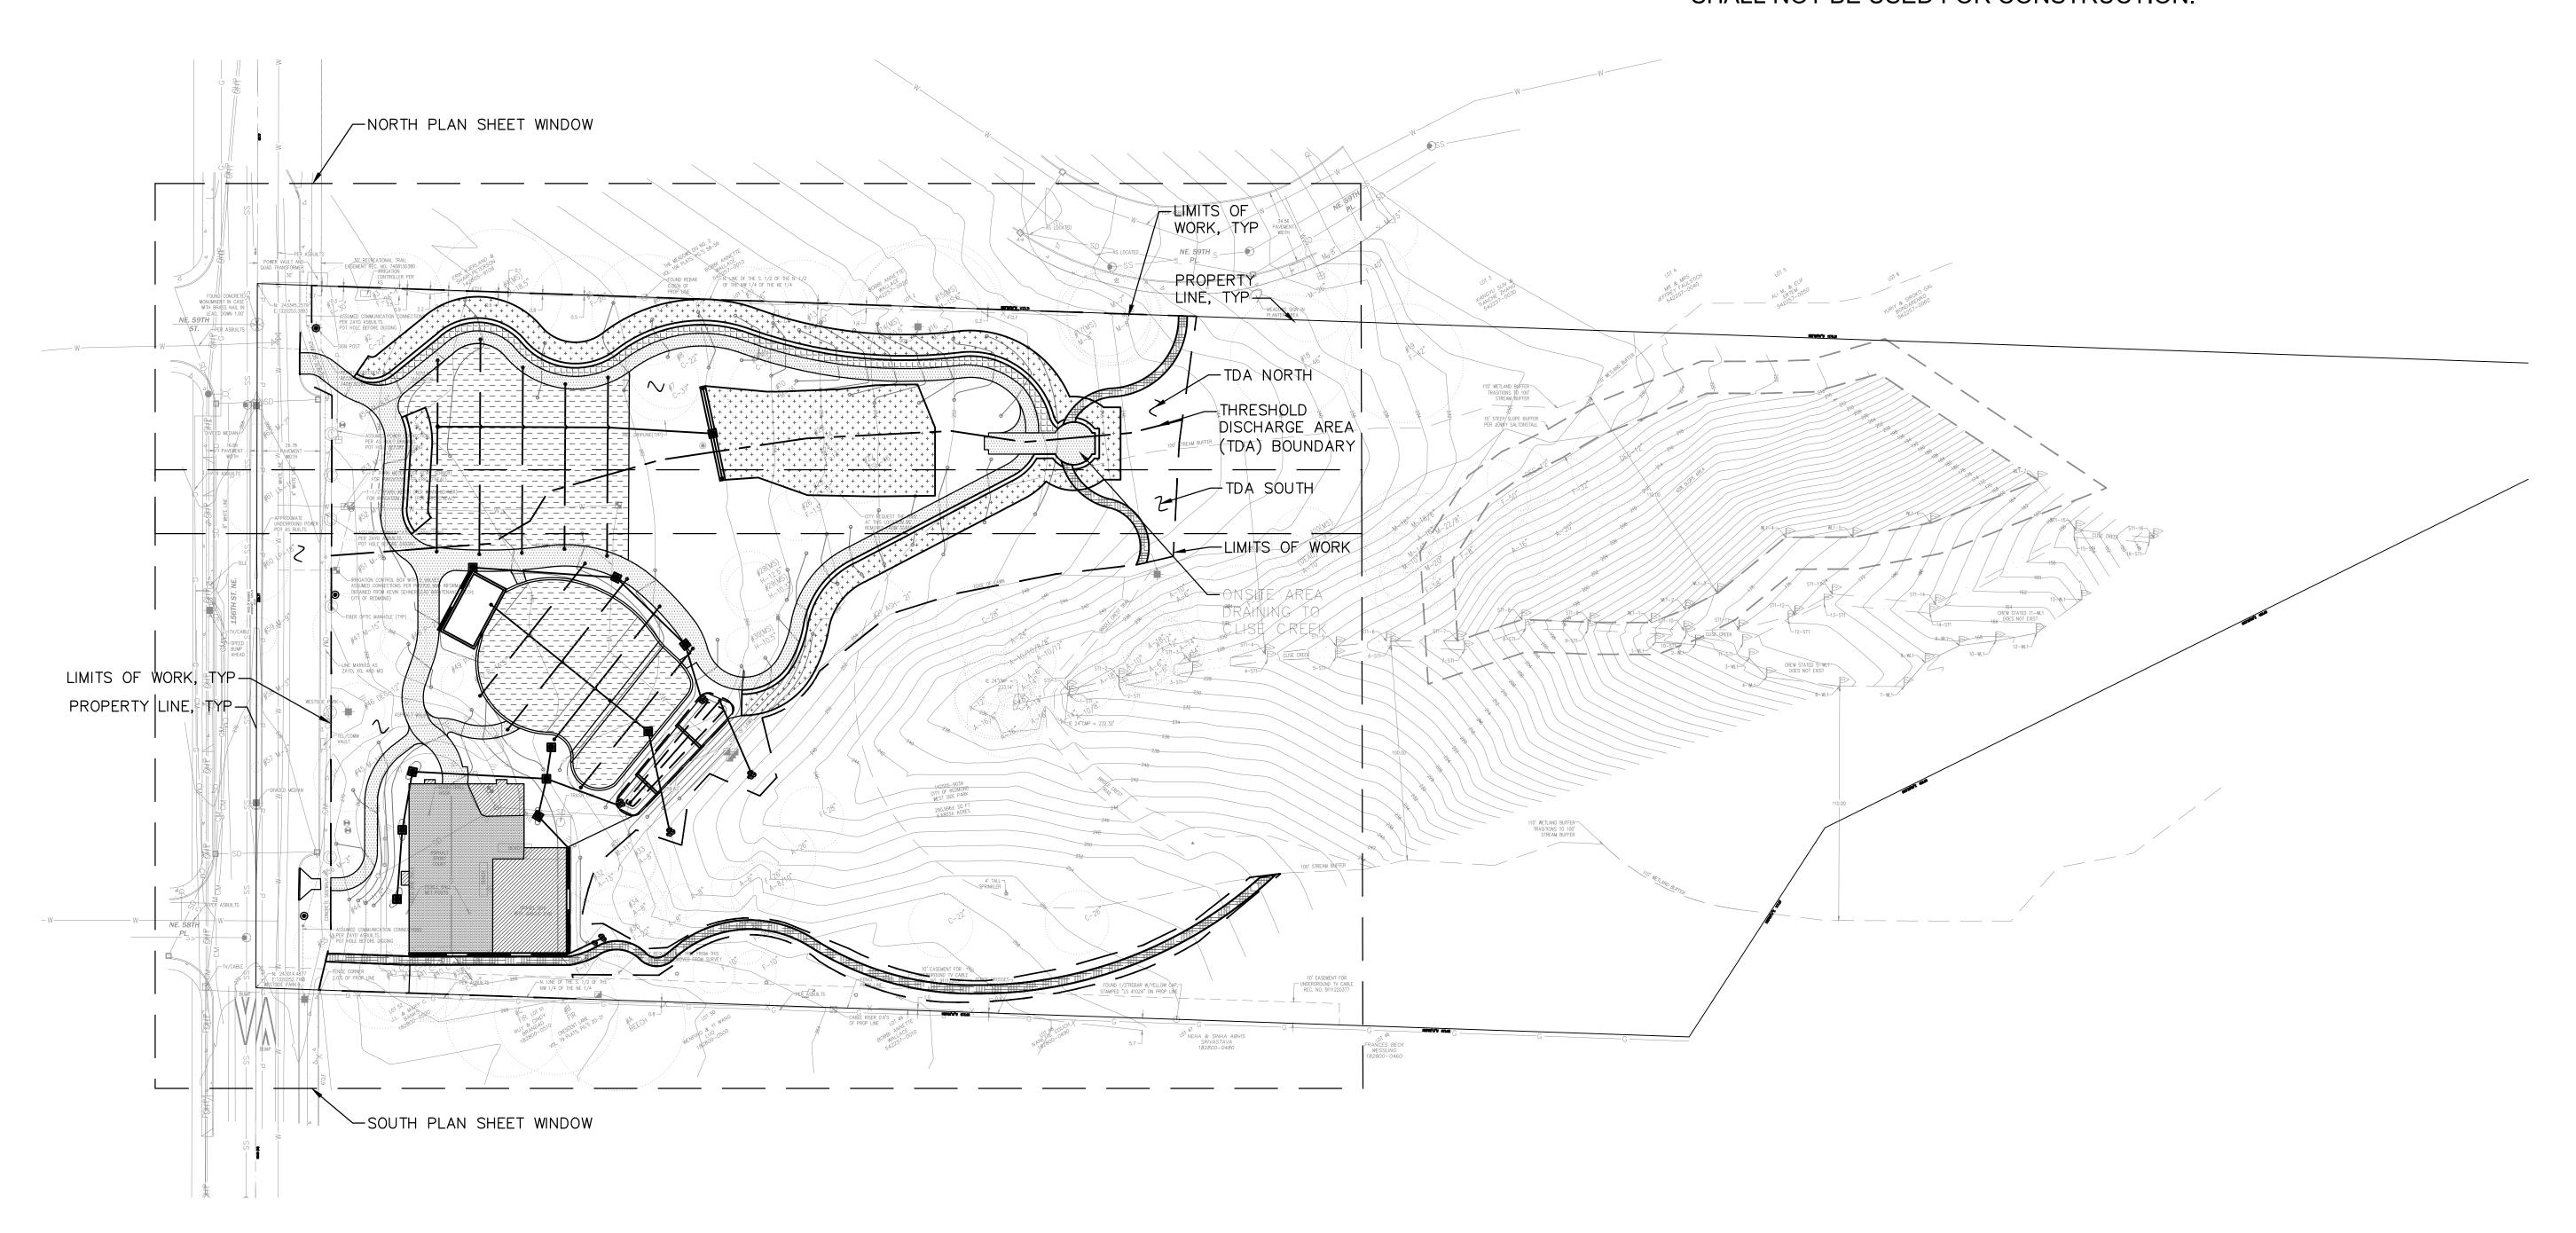
COMPOSITE PLNTG PLAN

L-200

SHEET NO.: 4 OF 35

COMPOSITE PLAN NOTES

- 1. SEE SHEET C1.0 FOR GENERAL NOTES, ABBREVIATIONS AND CITY OF REDMOND STANDARD NOTES.
- 2. THIS COMPOSITE PLAN IS INCLUDED FOR REFERENCE ONLY AND SHALL NOT BE USED FOR CONSTRUCTION.



Approved for Construction

Steve Flude, P.E. City Engineer

DATE

THIS DEVELOPMENT SHALL BE CONSTRUCTED IN ACCORDANCE WITH THE 2020 CITY OF REDMOND STANDARD SPECIFICATIONS AND DETAILS.

Dard & Vellum
115 15th Ave E. Suite 100 Seattle, WA 98112





DMOND WESTSIDE PARK NOVATION



ISSUANCES	

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 30% PLANS

04.20.2020 60% PLANS
04.30.2020 SITE PLAN ENTITLEMENT

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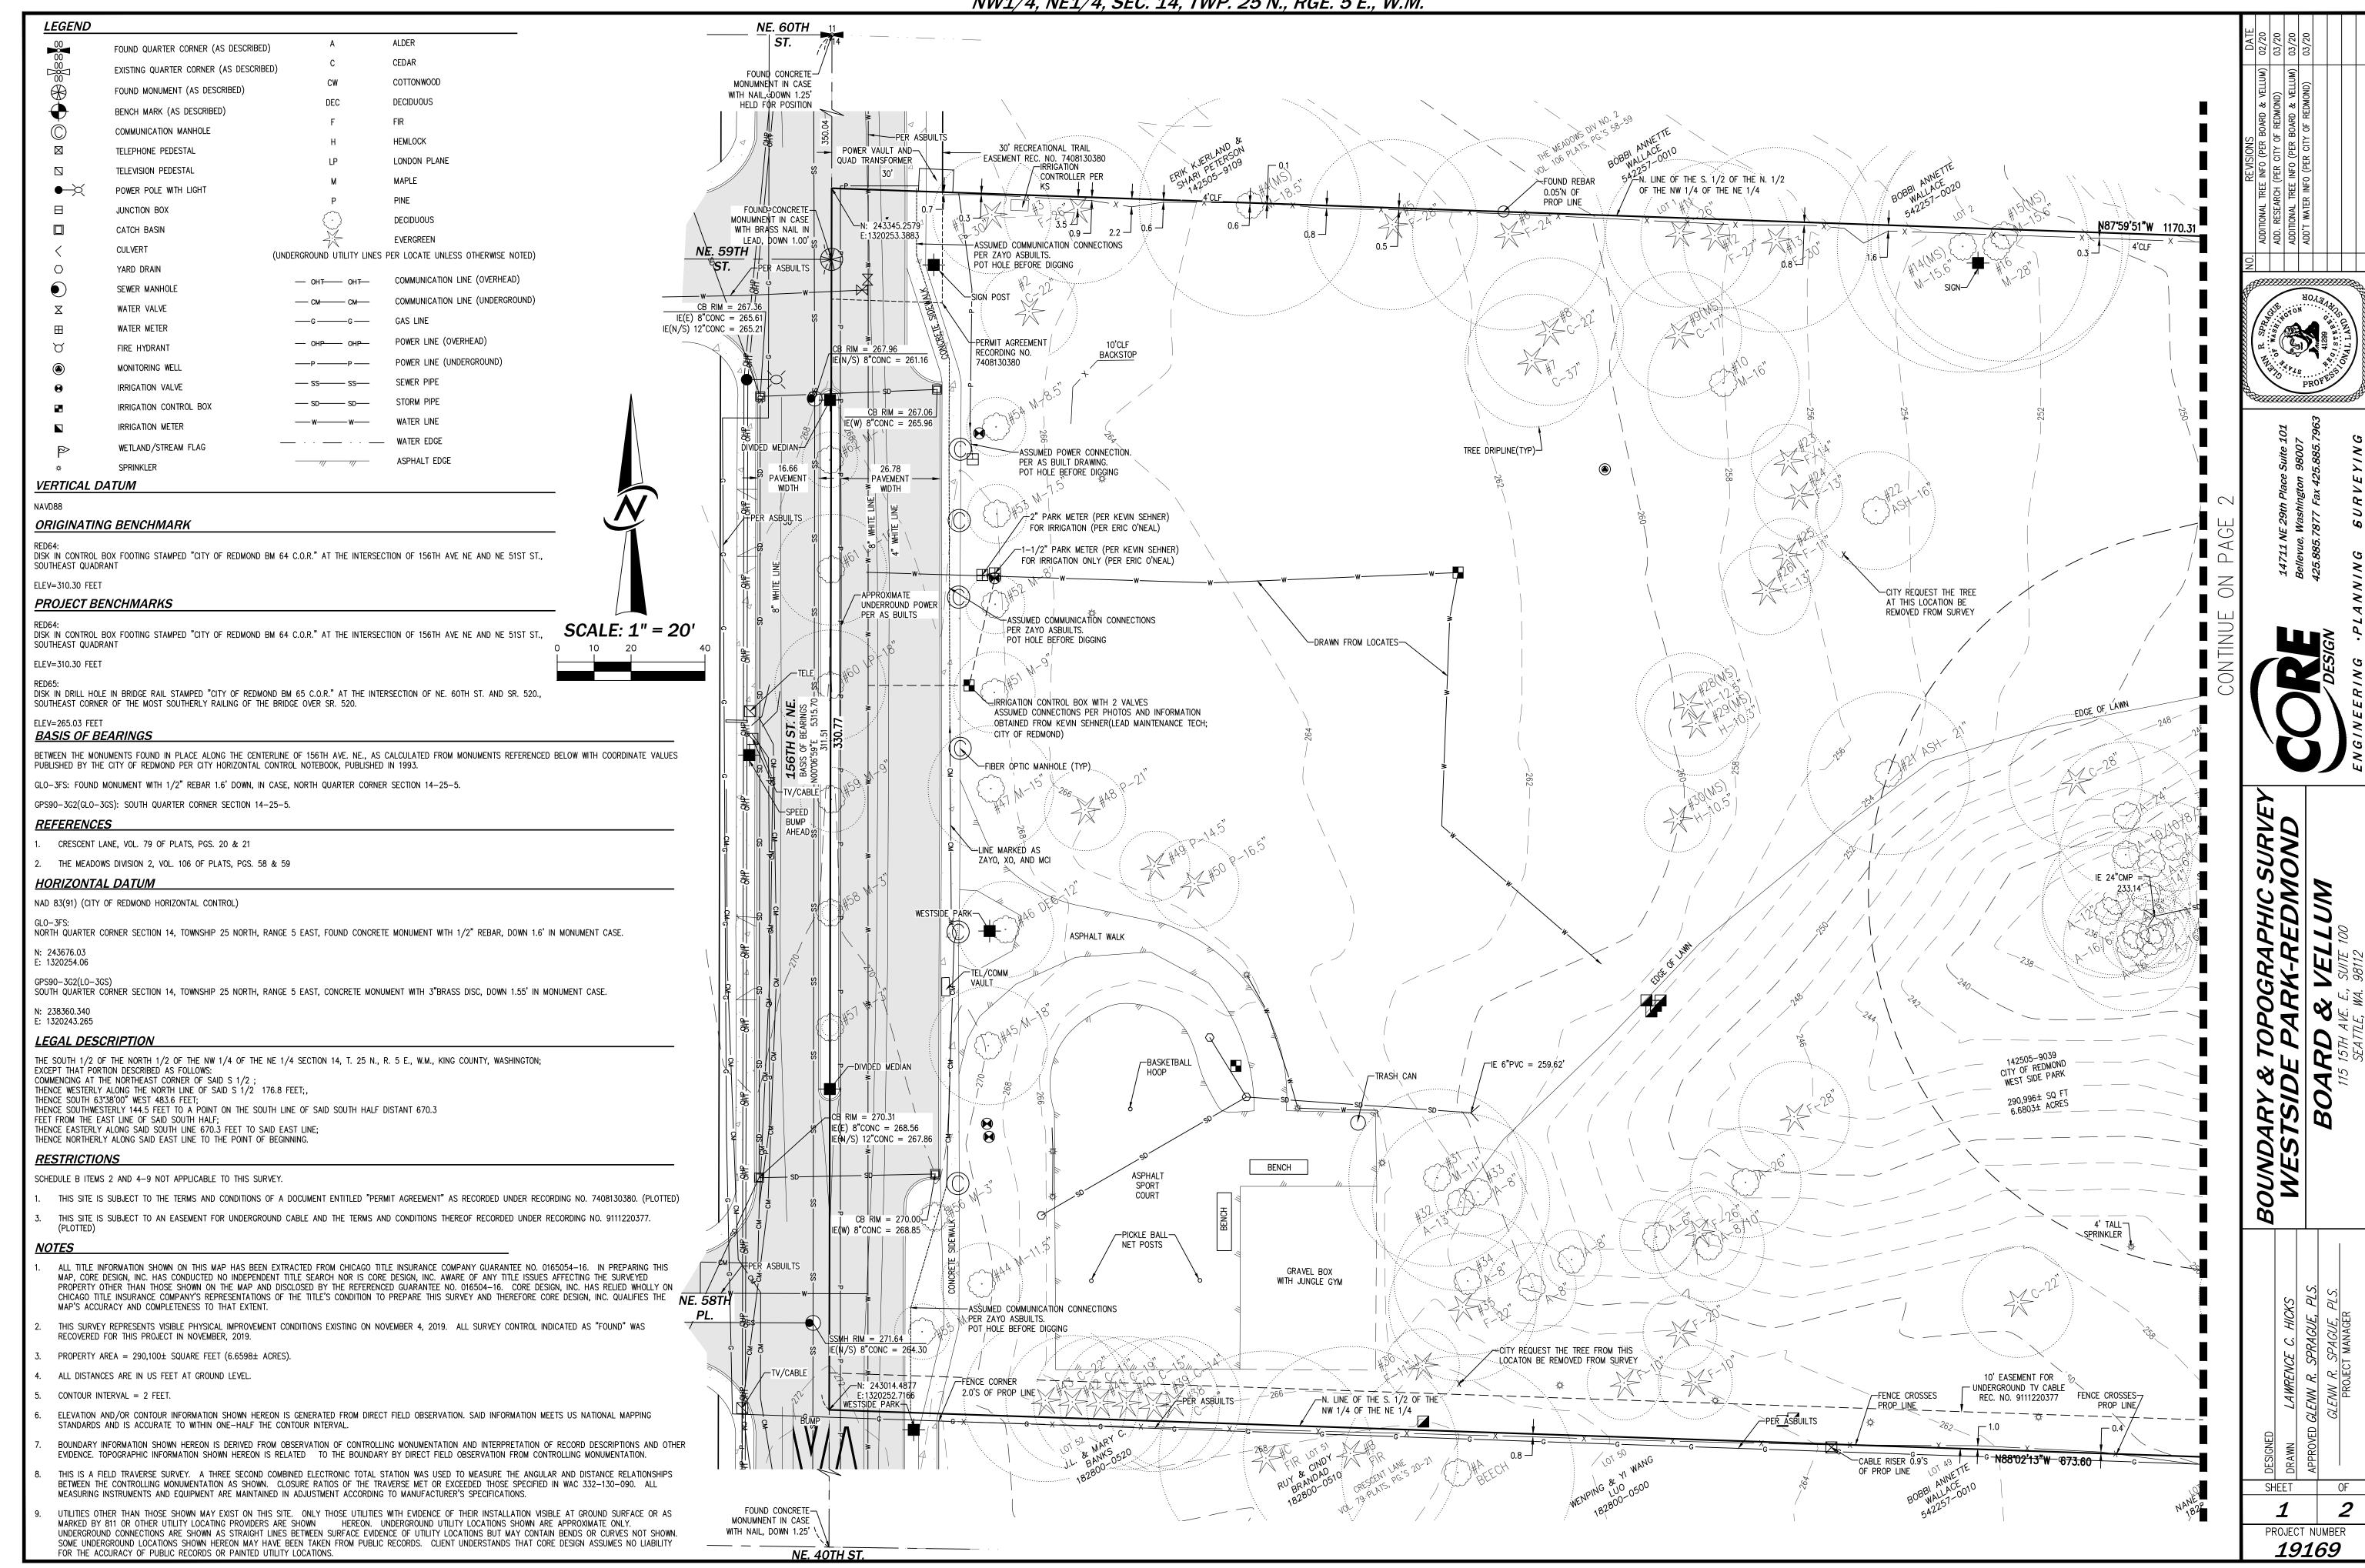
BOARD & VELLUM PROJECT #: 2019176.00

PROJECT #: 500021924

PLOT DATE: 04.30.2020

COMPOSITE
ENGINEERING PLAN
C-100

SHEET NO.: 5 OF 35



MONITORING WELL

19169

CIVIL SHEET INDEX

COMPOSITE

SD DETAILS 2

C-100

C4.5

C1.0	CIVIL COVER SHEET
C2.1	TESC PLAN NORTH
C2.2	TESC PLAN SOUTH
C2.3	TESC DETAILS 1
C2.4	TESC DETAILS 2
C3.1	DEMOLITION PLAN NORTH
C3.2	DEMOLITION PLAN SOUTH
C4.1	STORM DRAIN & UTILITY PLAN NORTH
C4.2	STORM DRAIN & UTILITY PLAN SOUTH
C4.3	DRAINAGE AREAS
C4.4	SD DETAILS 1

GENERAL NOTES

- 1. SURVEY BACKGROUND IS BASED ON THE PRELIMINARY SURVEY DATED 11-13-2019 PROVIDED BY CORE DESIGN.
- 2. CONTRACTOR SHALL HAVE A SET OF THE APPROVED PERMIT PLANS ON THE JOB SITE DURING CONSTRUCTION.
- 3. ALL WORK SHALL CONFORM TO THE 2020 CITY OF REDMOND STANDARD SPECIFICATIONS AND DETAILS AND THE 2020 WSDOT STANDARD SPECIFICATIONS FOR ROAD, BRIDGE AND MUNICIPAL CONSTRUCTION. A COPY OF THESE DOCUMENTS SHALL BE ON SITE DURING CONSTRUCTION.
- 4. THIS PROJECT IS CLASSIFIED AS LARGE PER CITY OF REDMOND SITE CLASSIFICATIONS.
- 5. CONTRACTOR TO MAINTAIN AN 8' CORRIDOR BETWEEN 156TH ST NE TO THE BRIDLE TRAILS TRAILHEAD AT ALL TIMES DURING CONSTRUCTION.

CITY OF REDMOND STANDARD NOTES

- 1. ALL WORK AND MATERIALS TO BE PER CITY OF REDMOND STANDARDS.
- 2. KEEP OFF-SITE STREETS CLEAN AT ALL TIMES. FLUSHING STREETS SHALL NOT BE ALLOWED. ALL STREETS SHOULD BE SWEPT.
- 3. ADDITIONAL EROSION/SEDIMENT CONTROL MEASURES MAY BE REQUIRED BY CITY INSPECTOR.
- 4. WHEN WORK IS STOPPED/COMPLETED IN AN AREA, THE CITY INSPECTOR MAY REQUIRE POST-CONSTRUCTION EROSION CONTROL INCLUDING SEEDING OR OTHER MEASURES.
- 5. LOCATIONS SHOWN OF EXISTING UTILITIES ARE APPROXIMATE. IT SHALL BE THE RESPONSIBILITY OF THE CONTRACTOR TO VERIFY THE CORRECT LOCATIONS TO AVOID DAMAGE OR DISTURBANCE.
- 6. IT SHALL BE THE RESPONSIBILITY OF THE CONTRACTOR TO OBTAIN STREET USE AND OTHER RELATED PERMITS PRIOR TO ANY CONSTRUCTION.
- 7. ALL GROUND COVER IS TO REMAIN UNDISTURBED OUTSIDE OF CLEARING AREAS.
- 8. THE TEMPORARY EROSION/SEDIMENT CONTROLS SHALL BE INSTALLED, INSPECTED, AND OPERATING BEFORE ANY GRADING OR EXTENSIVE LAND CLEARING. THESE CONTROLS MUST BE SATISFACTORILY MAINTAINED UNTIL CONSTRUCTION AND LANDSCAPING ARE COMPLETE.
- 9. TIE IMPERVIOUS SURFACES (ROOF, STREETS, DRIVEWAYS, ETC.) TO COMPLETED DRAINAGE SYSTEM AS SOON AS POSSIBLE.
- 10. A PRE-CONSTRUCTION MEETING WITH THE CONSTRUCTION DIVISION AND ALL PERMITS MUST BE COMPLETED BEFORE START OF CONSTRUCTION.
- 11. CLEARING LIMITS SHALL BE LOCATED BY A LICENSED CIVIL ENGINEER OR LAND SURVEYOR.
- 12. APPROVAL OF THIS TEMPORARY EROSION/SEDIMENTATION CONTROL (TESC) PLAN DOES NOT CONSTITUTE AN APPROVAL OF PERMANENT ROAD OR DRAINAGE DESIGN.
- 13. THIS APPROVAL FOR TESC IS VALID FOR CONSTRUCTION BETWEEN MAY 1 AND SEPTEMBER 30. THIS APPROVAL FOR TESC IS NOT VALID FOR THE RAINY SEASON (OCTOBER 1 THROUGH APRIL 30).
- 14. REMOVE ALL TESC MEASURES ONCE ALL WORK IS COMPLETED AND SITE IS PERMANENTLY STABILIZED.

ABBREVIATIONS

MIN

MJ

MINIMUM

MECHANICAL JOINT


			_
@	AT	N	NORTH, NORTHING
AB	ABANDON, ABANDONED	NTS	NOT TO SCALE
ADA	AMERICANS WITH DISABILITIES ACT	OC	ON CENTER
ADD	ADDITIONAL	OSM	ONSITE STORMWATER MANAGEMENT
AD	AREA DRAIN	PC	POINT OF CURVATURE
ASPH	ASPHALT	PCC	POINT OF COMPOUND CURVATURE
BC	BOTTOM OF CURB	PERF	PERFORATED
BLDG	BUILDING	PI	POINT OF INTERSECTION
BMP	BEST MANAGEMENT PRACTICE	PL	PROPERTY LINE
BW	BOTTOM OF WALL	PRC	POINT OF REVERSE CURVATURE
CB	CATCH BASIN	PSE	PUGET SOUND ENERGY
CF	CUBIC FEET	PT	POINT OF TANGENCY
CFS	CUBIC FEET PER SECOND	PVC	POINT OF VERTICAL CURVATURE,
CIP	CAST IN PLACE	FVC	POLYVINYL CHLORIDE
		DV/I	
CL	CENTERLINE CORRUGATED METAL DIDE	PVI	POINT OF VERTICAL TANGENCY
CMP	CORRUGATED METAL PIPE	PVT	POINT OF VERTICAL TANGENCY
CO	CLEAN OUT	R	RADIUS
COMM	COMMUNICATION	RJ	RESTRAINED JOINT
CONC	CONCRETE	ROW	RIGHT OF WAY
CONN	CONNECT, CONNECTION	RT	RIGHT
CONT	CONTINUED	S	SOUTH
COR	CITY OF REDMOND	SD	STORM DRAIN
CP	CONCRETE PIPE	SF	SQUARE FOOT
DEMO	DEMOLITION	SPEC	SPECIFICATIONS
DI	DUCTILE IRON	STD	STANDARD
DIA	DIAMETER	SS	SANITARY SEWER
DS	DOWNSPOUT	SW	STORMWATER
E	EAST, EASTING	TC	TOP OF CURB
EA	EACH	TDA	THRESHOLD DISCHARGE AREA
ELEC	ELECTRIC, ELECTRICAL	TESC	TEMPORARY EROSION AND
ELEV	ELEVATION		SEDIMENTATION CONTROL
ESC	EROSION AND SEDIMENT CONTROL	TEMP	TEMPORARY
EX	EXISTING	TW	TOP OF WALL
EXIST	EXISTING	TYP	TYPICAL
FD	FOUNDATION DRAIN PERFORATED PIPE	UNO	UNLESS NOTED OTHERWISE
FDCO	FOUNDATION DRAIN CLEAN OUT	UTIL	UTILITY
FF	FINISHED FLOOR		
		VERT	VERTICAL
FG	FINISHED GRADE	W	WATER, WEST
FH	FIRE HYDRANT	W/	WITH
FM	FORCE MAIN	WD	WALL DRAIN PERFORATED PIPE
GE	GROUND ELEVATION	WM	WATER METER
GEOTECH		WS	WATER SURFACE
GV	GATE VALVE	WSDOT	WASHINGTON STATE DEPARTMENT
HORIZ	HORIZONTAL		OF TRANSPORTATION
HTB	HORIZONTAL THRUST BLOCK		
ΙE	INVERT ELEVATION		
IRR	IRRIGATION		
JB	JUNCTION BOX		
LF	LINEAL FEET		
LOC	LOCATION		
LOW	LIMITS OF WORK		
LT	LEFT		
ME	MATCH EXISTING		
MH	MANHOLE		Approved for Construction
MAX	MAXIMUM		Steve Flude, P.E. DATE
MECH	MECHANICAL		City Engineer

Board & Vellum
115 15th Ave E. Suite 100 Seattle, WA 98112
info@boardandvellum.com | 206,707,8895





REDMOND WESTSIDE
RENOVATION

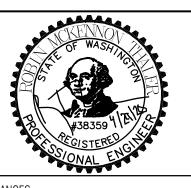

SUANCES

TE DESCRIPTION

02.26.2020 30% PLANS 04.20.2020 60% PLANS 04.30.2020 SITE PLAN ENTITLEMEN

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PROJECT #: 500021924

PLOT DATE: 04.30.2020

CIVIL COVER SHEET
C1.0

SHEET NO.: 8 OF 35

THIS DEVELOPMENT SHALL BE CONSTRUCTED IN ACCORDANCE WITH THE 2020 CITY OF REDMOND STANDARD SPECIFICATIONS AND

TEMPORARY EROSION AND SEDIMENT CONTROL (TESC) NOTES

- 1. SEE SHEET C1.0 FOR GENERAL NOTES, ABBREVIATIONS AND CITY OF REDMOND STANDARD NOTES.
- 2. SEE SHEET C2.2 FOR TESC LEGEND AND TESC RECOMMENDED CONSTRUCTION SEQUENCE.
- 3. THE LIMITS OF WORK SHOWN SHALL BE CLEARLY FLAGGED IN THE FIELD PRIOR TO CONSTRUCTION. DURING THE CONSTRUCTION PERIOD, NO DISTURBANCE BEYOND THE FLAGGED LIMITS OF WORK SHALL BE PERMITTED. THE FLAGGING SHALL BE MAINTAINED FOR THE DURATION OF CONSTRUCTION.
- 4. THE TESC BMPS SHOWN MUST BE CONSTRUCTED IN CONJUNCTION WITH ALL CLEARING AND GRADING ACTIVITIES, AND IN SUCH A MANNER AS TO ENSURE SEDIMENT AND SEDIMENT-LADEN WATER DO NOT ENTER THE DRAINAGE SYSTEM, ROADWAYS, OR VIOLATE APPLICABLE WATER QUALITY STANDARDS.
- 5. PROTECT EXPOSED SLOPES IN ACCORDANCE WITH DETAIL 10 ON SHEET C2.4.
- 6. REFERENCE TREE PRESERVATION PLAN FOR ALL WORK WITHIN THE TREE PROTECTION ZONE. NO DISTURBANCE IS ALLOWED WITHIN 5 FEET OF DRIP LINES OF TREES TO BE SAVED WITHOUT APPROVAL BY THE CITY OF REDMOND.
- 7. THE EROSION CONTROL MEASURES SHOWN ON THE DRAWINGS ARE CONSIDERED A MINIMUM, AND ADDITIONAL MEASURES MAY BE REQUIRED TO PROTECT ADJACENT PROPERTIES AND RECEIVING WATERS.
- 8. DAMAGE TO ANY DOWNSTREAM SYSTEMS DUE TO IMPROPERLY MAINTAINED EROSION CONTROL FACILITIES SHALL BE REPAIRED AT THE CONTRACTOR'S EXPENSE.
- 9. BEFORE BEGINNING ANY LAND DISTURBING ACTIVITIES, MARK ALL CLEARING LIMITS, SENSITIVE AREAS AND THEIR BUFFERS, AND TREES THAT ARE TO BE PRESERVED.
- 10. RETAIN THE DUFF LAYER, NATIVE TOP SOIL, AND NATURAL VEGETATION IN AN UNDISTURBED STATE TO THE MAXIMUM DEGREE PRACTICABLE.
- 11. ALL EQUIPMENT SHALL BE CLEANED PRIOR TO LEAVING THE SITE. IF THE CONSTRUCTION ENTRANCE IS NOT SUFFICIENT TO PREVENT TRACKING OF SEDIMENT ONTO ROADS, A WHEEL WASH OR TIRE BATHS SHALL BE INSTALLED ON SITE.
- 12. SEDIMENT SHALL BE REMOVED FROM ROADS BY SHOVELING, SWEEPING, OR PICKING UP AND TRANSPORTING THE SEDIMENT TO A CONTROLLED SEDIMENT DISPOSAL AREA.
- 13. STORMWATER RUNOFF FROM DISTURBED AREAS SHALL BE CONVEYED TO A SEDIMENT TRAP, OR OTHER SEDIMENT REMOVAL BMP, BEFORE DISCHARGING OFFSITE.
- 14. STABILIZE EXPOSED AND UNWORKED SOILS, INCLUDING STOCKPILES, AND AREAS THAT WILL BE EXPOSED FOR MORE THAN SEVEN DAYS BY APPLICATION OF EFFECTIVE BMPS, INCLUDING, BUT NOT LIMITED TO: TEMPORARY AND PERMANENT SEEDING, SODDING, MULCHING, PLASTIC

- SHEETING, AND EROSION CONTROL FABRICS AND MATTING.
- 15. SEED OR SOD ANY AREAS TO REMAIN UNCOVERED FOR MORE THAN 30 DAYS.
- 16. DESIGN AND CONSTRUCT CUT-AND-FILL SLOPES IN A MANNER TO MINIMIZE EROSION. DIVERT STORMWATER OR GROUND WATER AWAY FROM SLOPES AND DISTURBED AREAS WITH INTERCEPTOR DIKES, PIPES AND/OR SWALES.
- 17. PROTECT ALL STORM DRAIN INLETS DOWN SLOPE AND WITHIN 100 FEET OF THE SITE.
- 18. CONDUCT MAINTENANCE, FUELING, AND REPAIR OF HEAVY EQUIPMENT AND VEHICLES USING SPILL PREVENTION AND CONTROL MEASURES. CLEAN CONTAMINATED SURFACES IMMEDIATELY FOLLOWING ANY SPILL INCIDENT.
- 19. APPLY FERTILIZERS AND PESTICIDES IN A MANNER AND AT APPLICATION RATES THAT WILL NOT RESULT IN LOSS OF CHEMICAL TO STORMWATER RUNOFF.
- 20. USE BMPS TO PREVENT CONTAMINATION OF RUNOFF BY PH-MODIFYING SOURCES.
- 21. PROTECT BIORETENTION AND DISPERSION AREAS FROM SEDIMENTATION. RESTORE FACILITIES TO THEIR FULLY FUNCTIONING CONDITION IF SEDIMENT ACCUMULATES DURING CONSTRUCTION. RESTORATION INCLUDES REMOVAL OF SEDIMENT AND ANY SEDIMENT-LADEN SOILS, AND REPLACEMENT WITH SOILS MEETING THE SPECIFICATIONS.
- 22. KEEP ALL HEAVY EQUIPMENT OFF EXISTING SOILS UNDER BIORETENTION FACILITIES THAT HAVE BEEN EXCAVATED TO FINAL GRADE TO RETAIN THE INFILTRATION RATE OF THE SOILS. PREVENT COMPACTING CONSTRUCTED BIORETENTION FACILITIES BY EXCLUDING CONSTRUCTION EQUIPMENT AND FOOT TRAFFIC.
- 23. EXCAVATION SITE DEWATERING THAT INCLUDES DISCHARGE TO THE STREET, CATCH BASIN, OR SEWER SHALL BE IMPLEMENTED ONLY AFTER APPROVAL BY THE CITY OF REDMOND INSPECTOR.
- 24. CLEARING, GRADING AND OTHER SOIL DISTURBING ACTIVITIES MUST BE STABILIZED BY OCTOBER 1, AND SHALL NOT BE PERFORMED BETWEEN OCTOBER 1 AND APRIL 30 WITHOUT CITY OF REDMOND APPROVED WET WEATHER AND SEASONAL SUSPENSION PLANS.
- 25. CONTROL DUST IN COMPLIANCE WITH THE PUGET SOUND CLEAN AIR AGENCY.
- 26. WORK IN CRITICAL AREAS MUST CONFORM TO THE CITY OF REDMOND'S CRITICAL AREAS ORDINANCE.

Approved for Construction

Steve Flude, P.E.


THIS DEVELOPMENT SHALL BE CONSTRUCTED IN ACCORDANCE WITH THE 2020 CITY OF REDMOND STANDARD SPECIFICATIONS AND DETAILS

Board & Vellur





EDMOND WESTSIDE PARK ENOVATION

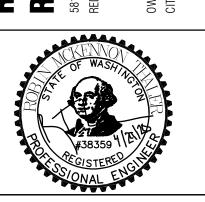

SUANCES

02.26.2020 30% PLANS 04.20.2020 60% PLANS

04.30.2020 SITE PLAN ENTITLEMENT

DESCRIPTION

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ORIGINAL SHEET SIZE IS 22"x34"

BOARD & VELLUM PROJECT #: 2019176.00


PROJECT #: 500021924

PLOT DATE: 04.30.2020

TESC PLAN NORTH

C2 1

SHEET NO.: 9 OF 35

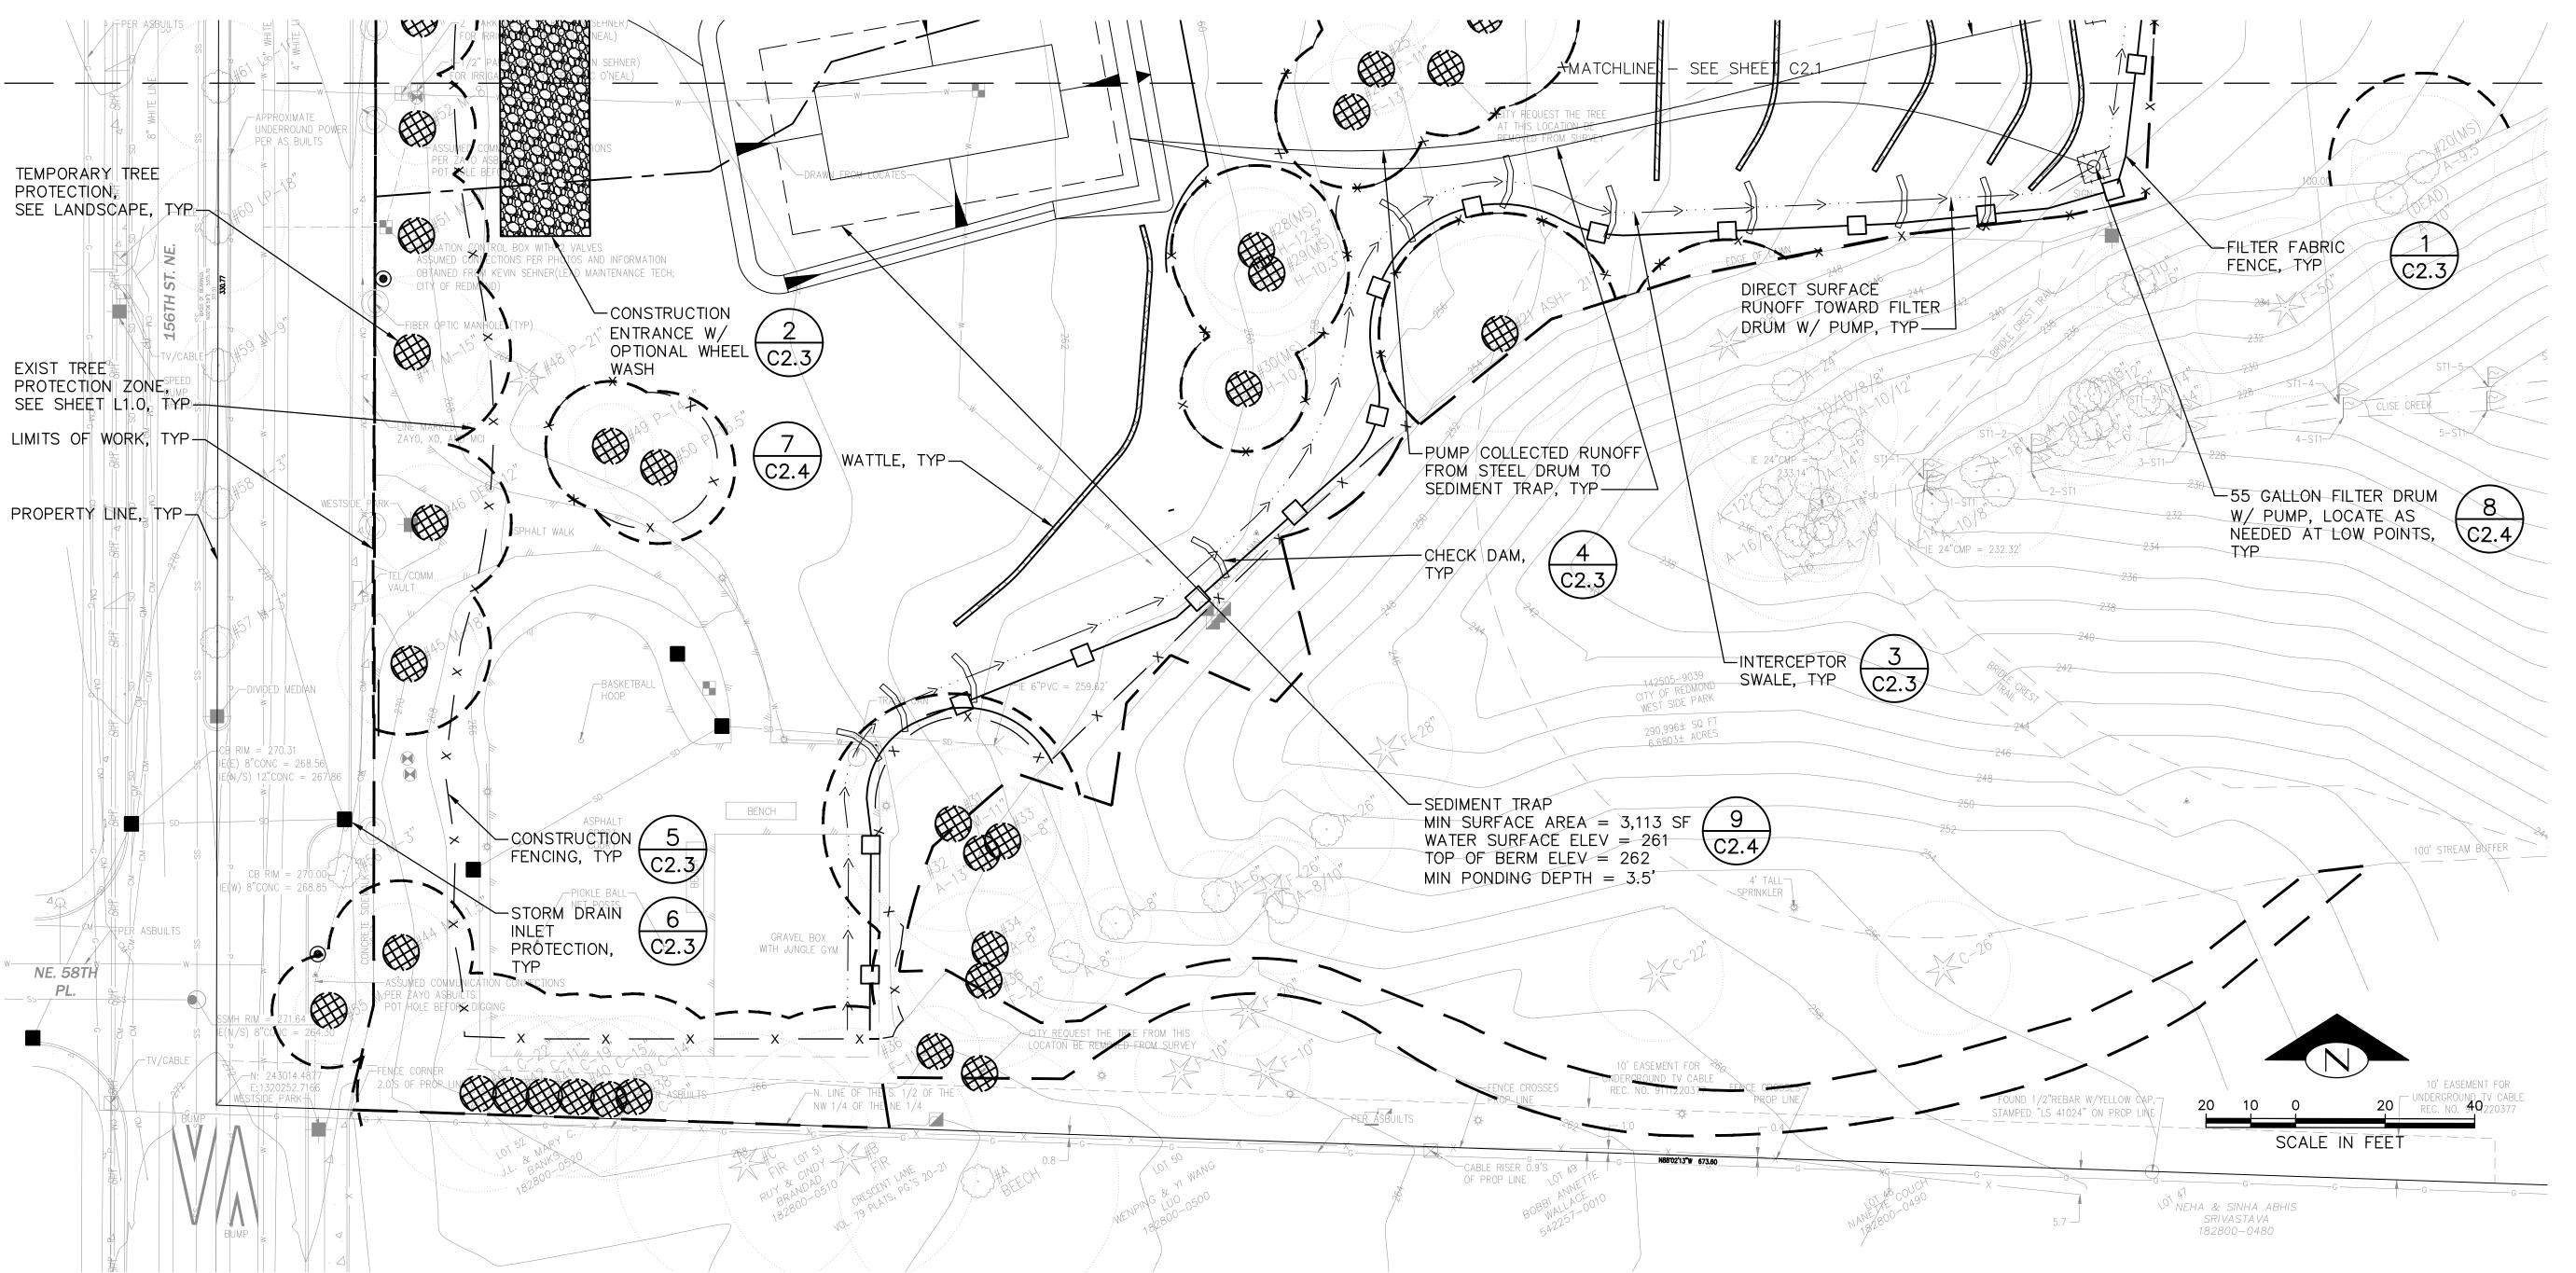

TESC LEGEND

PRE-CONSTRUCTION MEETING WITH CITY OF REDMOND.

LIMITS OF WORK (LOW) TREE PROTECTION ZONE

FILTER FABRIC FENCE

INTERCEPTOR SWALE

CHECK DAM $\left(\frac{4}{C2.3}\right)$

CONSTRUCTION ENTRANCE

CONSTRUCTION FENCING

STORM DRAIN INLET PROTECTION $\binom{6}{C2.3}$

- FENCE CLEARING LIMITS AND INSTALL TREE PROTECTION. INSTALL STORM DRAIN INLET PROTECTION AND CONSTRUCTION ENTRANCE.
- INSTALL PERIMETER PROTECTION (FILTER FABRIC FENCE, WATTLES, ETC.)
- INSPECT, MAINTAIN AND REPAIR ALL BMPS DAILY OR AS DIRECTED BY THE CITY OF REDMOND CONSTRUCTION INSPECTOR TO ENSURE CONTINUED PERFORMANCE OF INTENDED FUNCTION.

TESC RECOMMENDED CONSTRUCTION SEQUENCE

- KEEP ALL ADJACENT STREETS SWEPT CLEAN AND FREE FROM CONSTRUCTION SEDIMENT AND DEBRIS.
- RELOCATE EROSION CONTROL MEASURES OR INSTALL NEW MEASURES SO THAT AS SITE CONDITIONS CHANGE, THE EROSION AND SEDIMENT CONTROL IS ALWAYS IN ACCORDANCE WITH CITY OF REDMOND STANDARDS.
- STABILIZE ALL AREAS THAT REACH FINAL GRADE WITHIN SEVEN DAYS.
- UPON COMPLETION OF THE PROJECT, ALL DISTURBED AREAS MUST BE STABILIZED AND BMPS REMOVED WHEN APPROPRIATE.

TESC NOTES

- SEE SHEET C1.0 FOR GENERAL NOTES, ABBREVIATIONS AND CITY OF REDMOND STANDARD NOTES.
- 2. SEE SHEET C2.1 FOR ADDITIONAL TESC NOTES.

Approved for Construction

Steve Flude, P.E. City Engineer DATE


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DATE DESCRIPTION 02.26.2020 30% PLANS

04.20.2020 60% PLANS 04.30.2020 SITE PLAN ENTITLEMENT


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2019176.00 500021924 PLOT DATE: 04.30.2020


TESC PLAN SOUTH C2.2

10 of 35

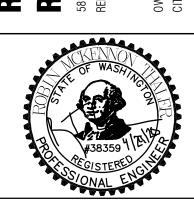
FILTER DRUM W/ PUMP $(\frac{8}{22})$ TEMPORARY TREE PROTECTION, SEE LANDSCAPE SEDIMENT TRAP WATER SURFACE



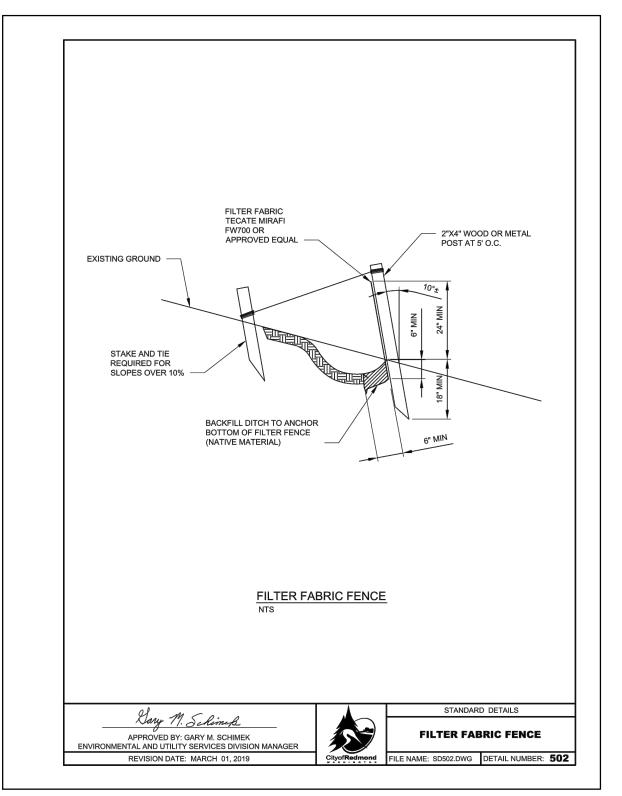


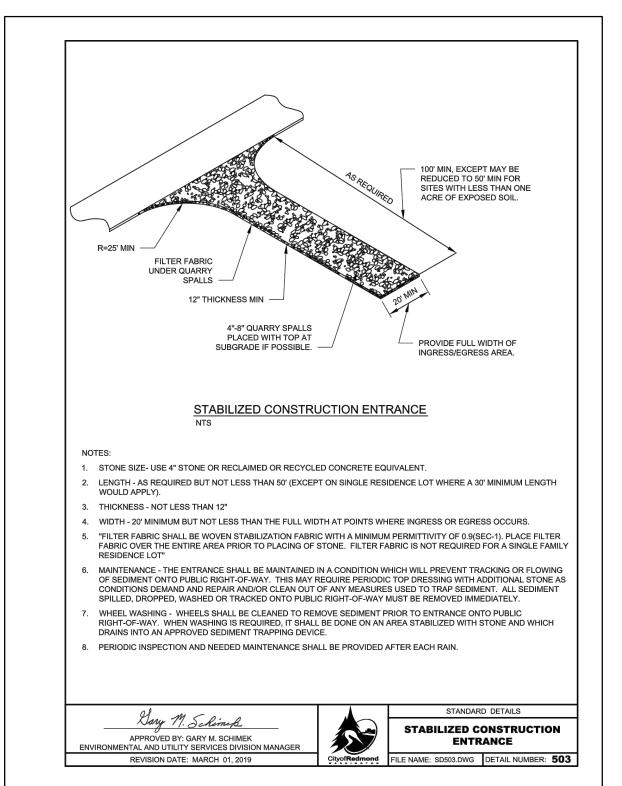



CONSTRUCTION ENTRANCE W/ OPTIONAL WHEEL WASH

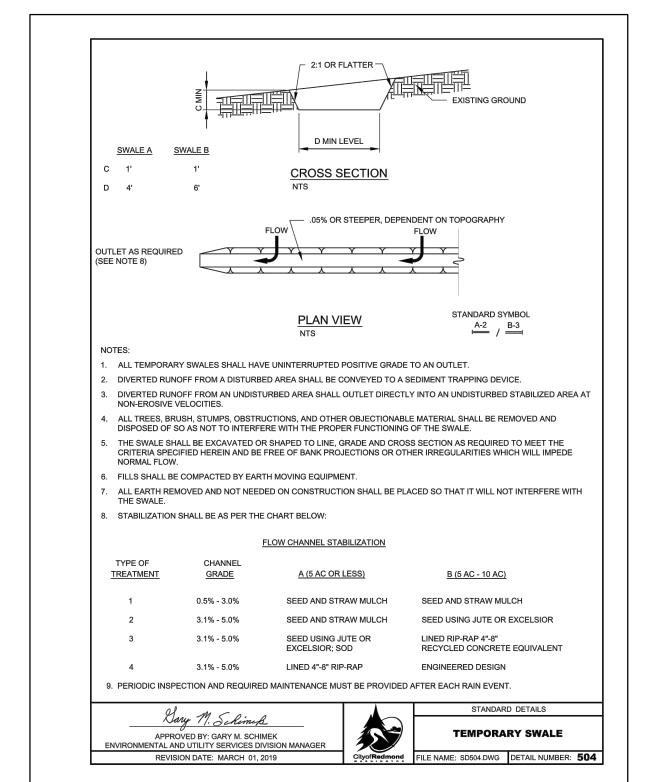

INTECEPTOR SWALE

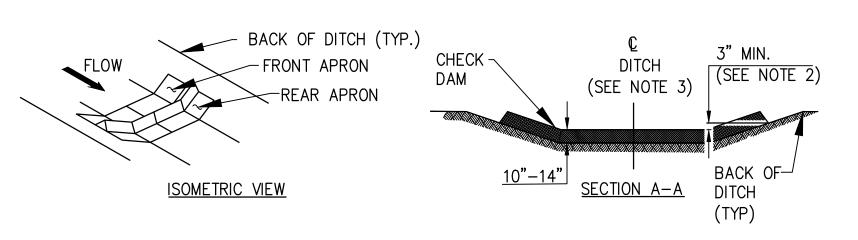


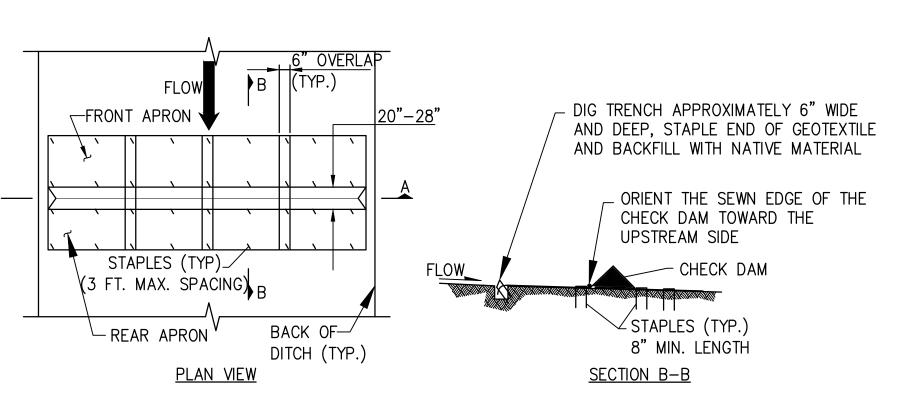

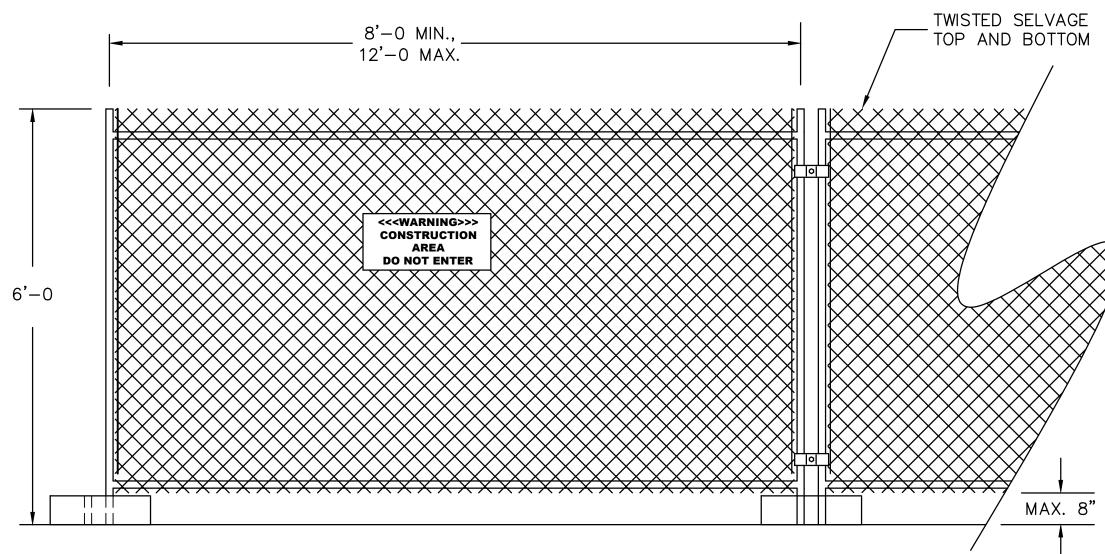

- GEOTEXTILE MATERIAL FOR ENCASED CHECK DAMS SHALL BE IN ACCORDANCE WITH THE SPECIFICATIONS..
- 2. INSTALL THE SLOPED ENDS OF THE CHECK DAM A MINIMUM OF 3" HIGHER THAN THE TOP OF THE CHECK DAM IN THE CHANNEL TO ENSURE THAT WATER FLOWS OVER THE DAM AND NOT AROUND IT.
- 3. FLAT BOTTOM DITCH DESIGN SHOWN, CHECK DAM INSTALLATION DETAILS ARE SIMILAR FOR "V" BOTTOM DITCHES.
- 4. CHECK DAMS SHALL BE INSPECTED AND MAINTAINED WHEN A 1/2 INCH RAIN ACCUMULATES WITHIN A 24 HOUR PERIOD. REMOVE SEDIMENT WHEN ONE HALF OF THE SUMP DEPTH IS FILLED WITH SEDIMENTS.

- 1. CHAIN LINK FABRIC TO BE MIN. 11 GAUGE, GALVANIZED. NO RUSTED OR EXCESSIVELY MALFORMED
- 2. FENCE BASES SHALL BE OF SUFFICIENT WEIGHT AND/OR SPREAD TO ADEQUATELY SUPPORT EACH PANEL. 3. PANEL-TO-PANEL CONNECTIONS SHALL BE MADE AT A MIN. TWO LOCATIONS PER CONNECTION UNLESS OTHERWISE APPROVED.
- 4. PROVIDE CONSTRUCTION WARNING SIGNAGE 50'O.C. ALONG FENCING INSTALLATION.

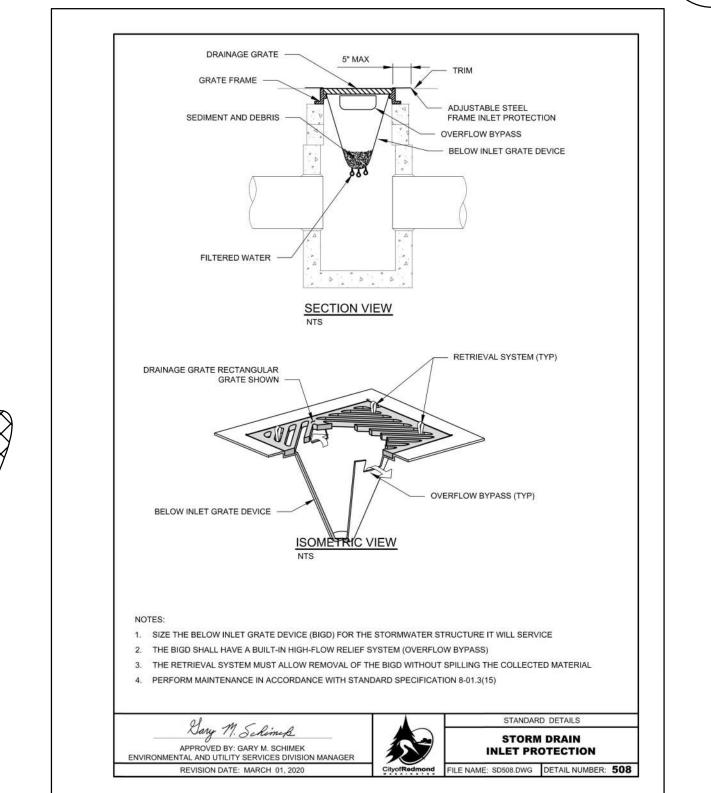



Approved for Construction

Steve Flude, P.E. City Engineer DATE

THIS DEVELOPMENT SHALL BE CONSTRUCTED IN ACCORDANCE WITH THE 2020 CITY OF REDMOND STANDARD SPECIFICATIONS AND

C2.1,C2.2

CHECK DAM

CONSTRUCTION FENCING NTS

SHEET NO.: 11 OF 35

TESC DETAILS 1

ellu

MAYFLY

ENGINEERING + DESIGN, PLL

www.mayflyeng.com | v 206.935.5356 5042 49th avenue sw seattle, wa 98136

PARK

WESTSIDE ION

REDMONI Renovat

ISSUANCES

DESCRIPTION

04.30.2020 SITE PLAN ENTITLEMENT

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BOARD & VELLUM PROJECT #: 2019176.00

500021924

04.30.2020

02.26.2020 30% PLANS


04.20.2020 60% PLANS

DATE


PROJECT #:

PLOT DATE:

SHEET:

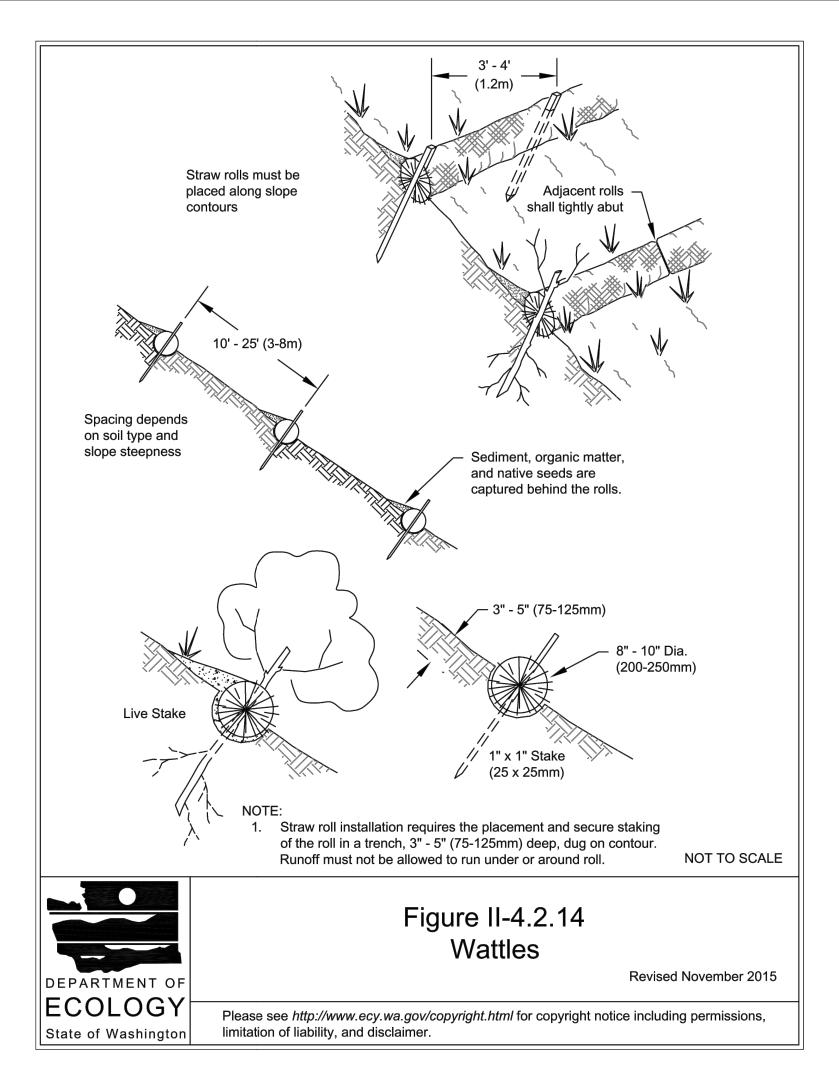


WATTLE 7
VTS
C2.1,C2.2

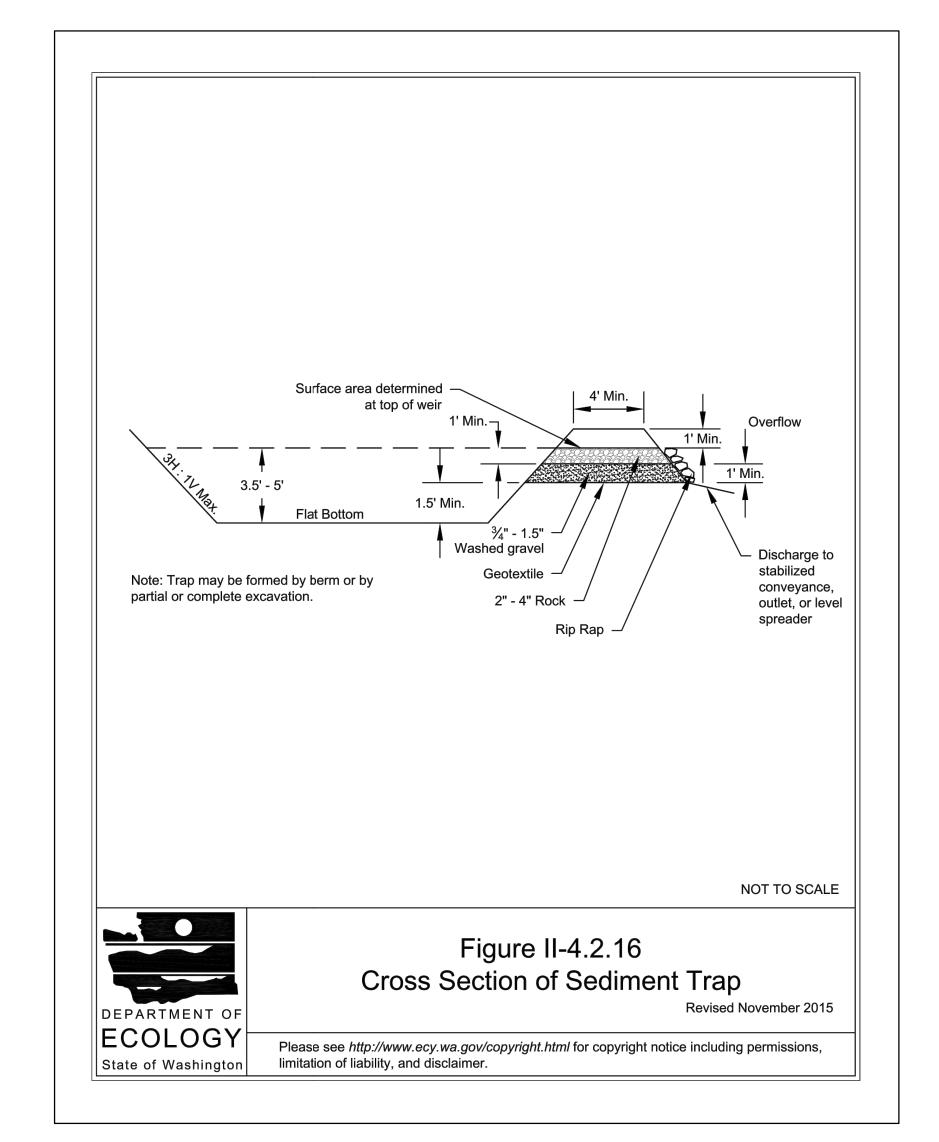

SEDIMENT TRAP

NTS

(2.1,C)

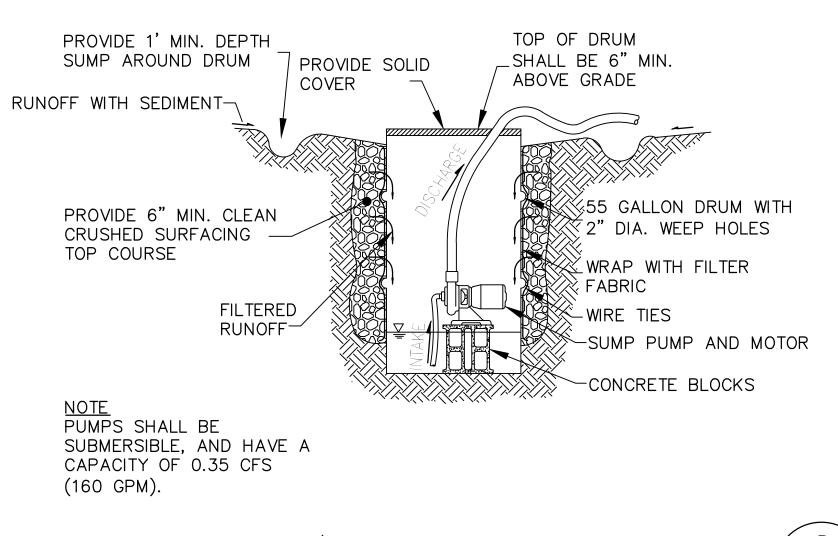

FILTER DRUM W/ PUMP




PURPOSE:
TO PROVIDE IMMEDIATE
PROTECTION TO EXPOSED
SOILS DURING THE PERIOD OF
SHORT CONSTRUCTION DELAYS

NOTE:
USE JUTE MATTING OR OTHER
BIODEGRADABLE MATERIAL

SHALLOW SLOPE
(<3:1)

ON STEEP SLOPES, APPLY STRIPS OF NETTING PARALLEL TO THE DIRECTION OF THE FLOW AND ANCHOR SECURELY

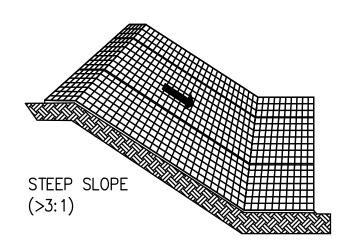



Approved for Construction

DATE

THIS DEVELOPMENT SHALL BE CONSTRUCTED IN ACCORDANCE WITH THE 2020 CITY OF REDMOND STANDARD SPECIFICATIONS AND DETAILS.

Steve Flude, P.E. City Engineer

WHERE THERE IS A BERM AT THE TOP OF THE SLOPE, BRING THE NETTING OVER THE BERM AND ANCHOR IT BEHIND THE BERM


TEMPORARY SLOPE PROTECTION NTS

(10) C2.1)

REDMOND WESTSIDE RENOVATION

PARK

OWNER:

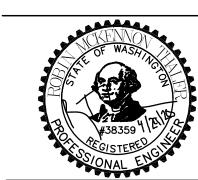

/ellur

Board

MAYFLY

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ISSUANCES

DATE DESCRIPTION

02.26.2020 30% PLANS

04.20.2020 60% PLANS
04.30.2020 SITE PLAN ENTITLEMENT

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BOARD & VELLUM PROJECT #: 2019176.00

PROJECT #: 500021924


PLOT DATE: 04.30.2020

SHEET:

TESC DETAILS 2

C2.4

SHEET NO.: 12 of 35

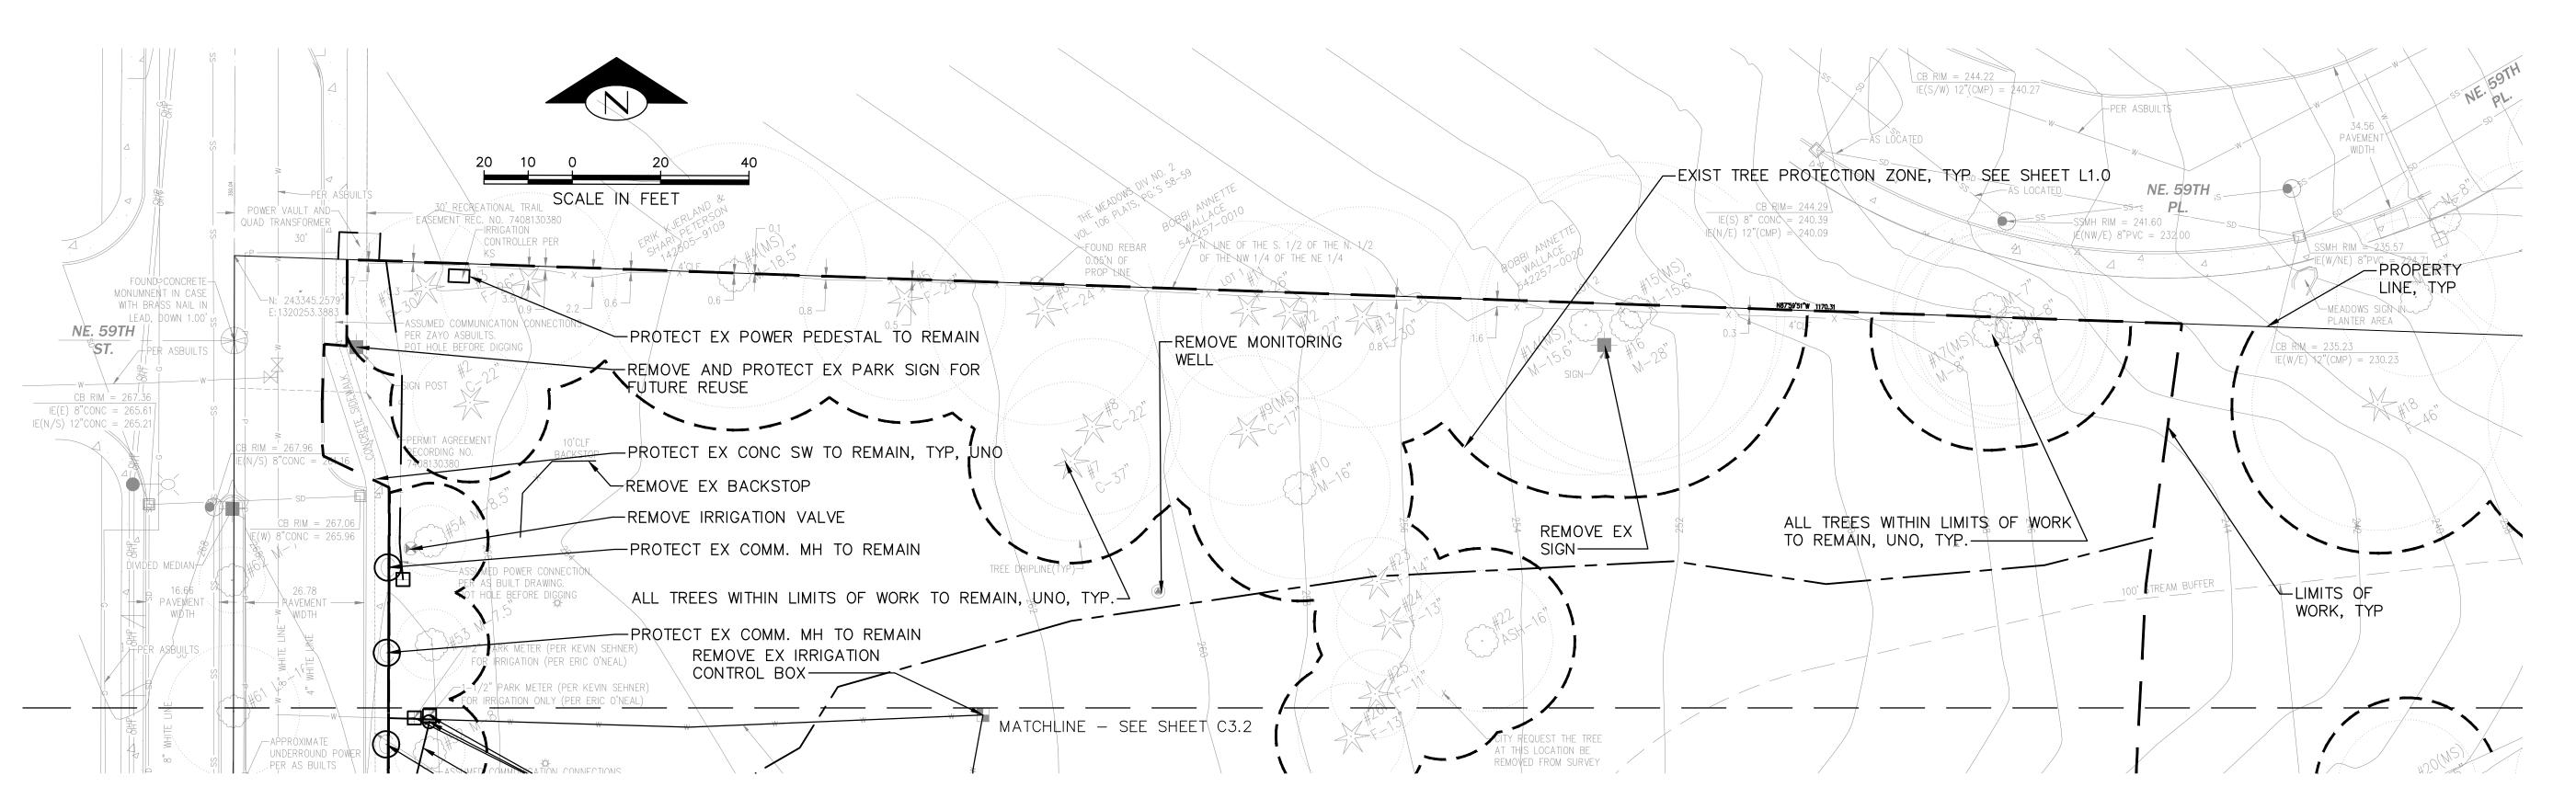

DEMOLITION NOTES

- 1. SEE SHEET C1.0 FOR GENERAL NOTES, ABBREVIATIONS AND CITY OF REDMOND STANDARD NOTES.
- 2. THE CONTRACTOR SHALL PROVIDE, ERECT AND MAINTAIN ALL TEMPORARY AND SECURITY DEVICES AS NECESSARY FOR THE PROTECTION OF THE ADJACENT EXISTING IMPROVEMENTS.
- 3. REFERENCE THE DRAFT GEOTECHNICAL REPORT PREPARED BY ASSOCIATED EARTH SCIENCES, INC, DATED JAN 23, 2020 FOR REQUIREMENTS AND RECOMMENDATIONS INCLUDING CLEARING AND SITE PREPARATION, EXCAVATION, TEMPORARY CUT SLOPES AND OTHER EARTHWORK CONSIDERATIONS.
- 4. NA
- 5. THE CONTRACTOR SHALL COORDINATE THE REMOVAL, ABANDONMENT AND/OR CAPPING OF EXISTING UTILITIES WITH THE APPLICABLE UTILITY AGENCY, INCLUDING BUT NOT LIMITED TO EXISTING WATER CONNECTIONS.
- 6. EXCAVATION FOR REMOVAL OF FOUNDATIONS, SLABS ON GRADE AND UTILITIES SHALL BE IN ACCORDANCE WITH THE DRAFT GEOTECHNICAL REPORT PREPARED BY ASSOCIATED EARTH SCIENCES, INC, DATED JAN 23, 2020. THE CONTRACTOR SHALL COMPLY WITH THE REPORT RECOMMENDATIONS FOR TEMPORARY CONSTRUCTION SLOPES AND SHALL NOT EXCEED THOSE SLOPES WITHOUT PRIOR APPROVAL OF THE GEOTECHNICAL ENGINEER.
- 7. CAP OR PLUG UTILITY SERVICES AT THE LIMITS OF EXCAVATION OR AT THE LIMITS OF WORK, UNLESS NOTED OTHERWISE.
- 8. DEMOLITION ASSOCIATED WITH ELECTRICAL LINES AND APPURTENANCES SHALL BE COORDINATED WITH THE ELECTRICAL DRAWINGS. DEMOLITION FOR SPECIFIC ELECTRICAL ITEMS INDICATED ON THE DEMOLITION PLANS SHALL NOT BE CARRIED OUT UNTIL POWER SOURCES TO THE

- ITEMS INDICATED FOR REMOVAL HAVE BEEN MADE SAFE.
- 9. REMOVE EXISTING CONCRETE AND ASPHALT PAVEMENT TO FULL DEPTH.
- 10. PROTECT ALL EXISTING STRUCTURES AND FOUNDATIONS TO REMAIN WITHIN THE LIMITS OF WORK DURING CONSTRUCTION. CONTRACTOR SHALL PROVIDE SHORING AS REQUIRED IN ORDER TO NOT IMPACT EXISTING STRUCTURES, FOUNDATIONS AND RETAINING WALLS.
- 11. CAP ALL REMOVED UTILITIES ON PLAN AT LOCATION DESIGNATED BY ENGINEER.
- 12. PROTECT ALL EXISTING UTILITIES TO REMAIN FROM DAMAGE AT ALL TIMES DURING CONSTRUCTION. CONTRACTOR SHALL PROVIDE TEMPORARY SHORING AS REQUIRED TO ENSURE ADEQUATE PROTECTION OF UTILITIES TO REMAIN AND THEIR APPURTENANCES. CONTRACTOR SHALL FIELD VERIFY EXISTING CONDITIONS PRIOR TO COMMENCEMENT OF DEMOLITION OPERATIONS AND NOTIFY THE ENGINEER OF ANY DISCREPANCIES.
- 13. PROTECT ALL TREES TO REMAIN FROM DAMAGE DURING CONSTRUCTION IN ACCORDANCE WITH THE TREE PROTECTION PLAN AND THE ARBORIST REPORT.
- 14. ANY WORK TO BE DONE WITHIN A TREE PROTECTION ZONE AS NOTED ON THE TREE PROTECTION PLAN MUST BE DONE BY HAND OR AIR SPADE.
- 15. LIMITS OF TREE REMOVAL SHALL INCLUDE STUMPS AND ROOTS TO A MINIMUM OF THREE FEET BELOW FINISH GRADE.
- 16. REFERENCE TREE PRESERVATION PLAN FOR ALL WORK WITHIN THE TREE PROTECTION ZONE.
- 17. CONTRACTOR TO MAINTAIN AN 8' CORRIDOR BETWEEN 156TH ST NE TO THE BRIDLE TRAILS TRAILHEAD AT ALL TIMES DURING CONSTRUCTION.

DEMOLITION LEGEND

— — LIMITS OF WORK
— — TREE PROTECTION ZONE
— ITEM TO REMAIN OR BE ABANDONED
— ITEM TO BE REMOVED OR SALVAGED

Approved for Construction

Steve Flude, P.E. DATE
City Engineer


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oard & Vellum
115 15th Ave E. Suite 100 Seattle, WA 98112





REDMOND WESTSIDE PARK
RENOVATION
5810 156TH AVENE

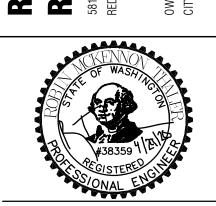

ISSUANCES

DATE DESCRIPTION

02.26.2020 30% PLANS

04.20.2020 60% PLANS
04.30.2020 SITE PLAN ENTITLEMENT


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ORIGINAL SHEET SIZE IS 22"x34"

BOARD & VELLUM PROJECT #: 2019176.00

PROJECT #: 500021924

PLOT DATE: 04.30.2020

DEMOLITION PLAN
NORTH
C3.1

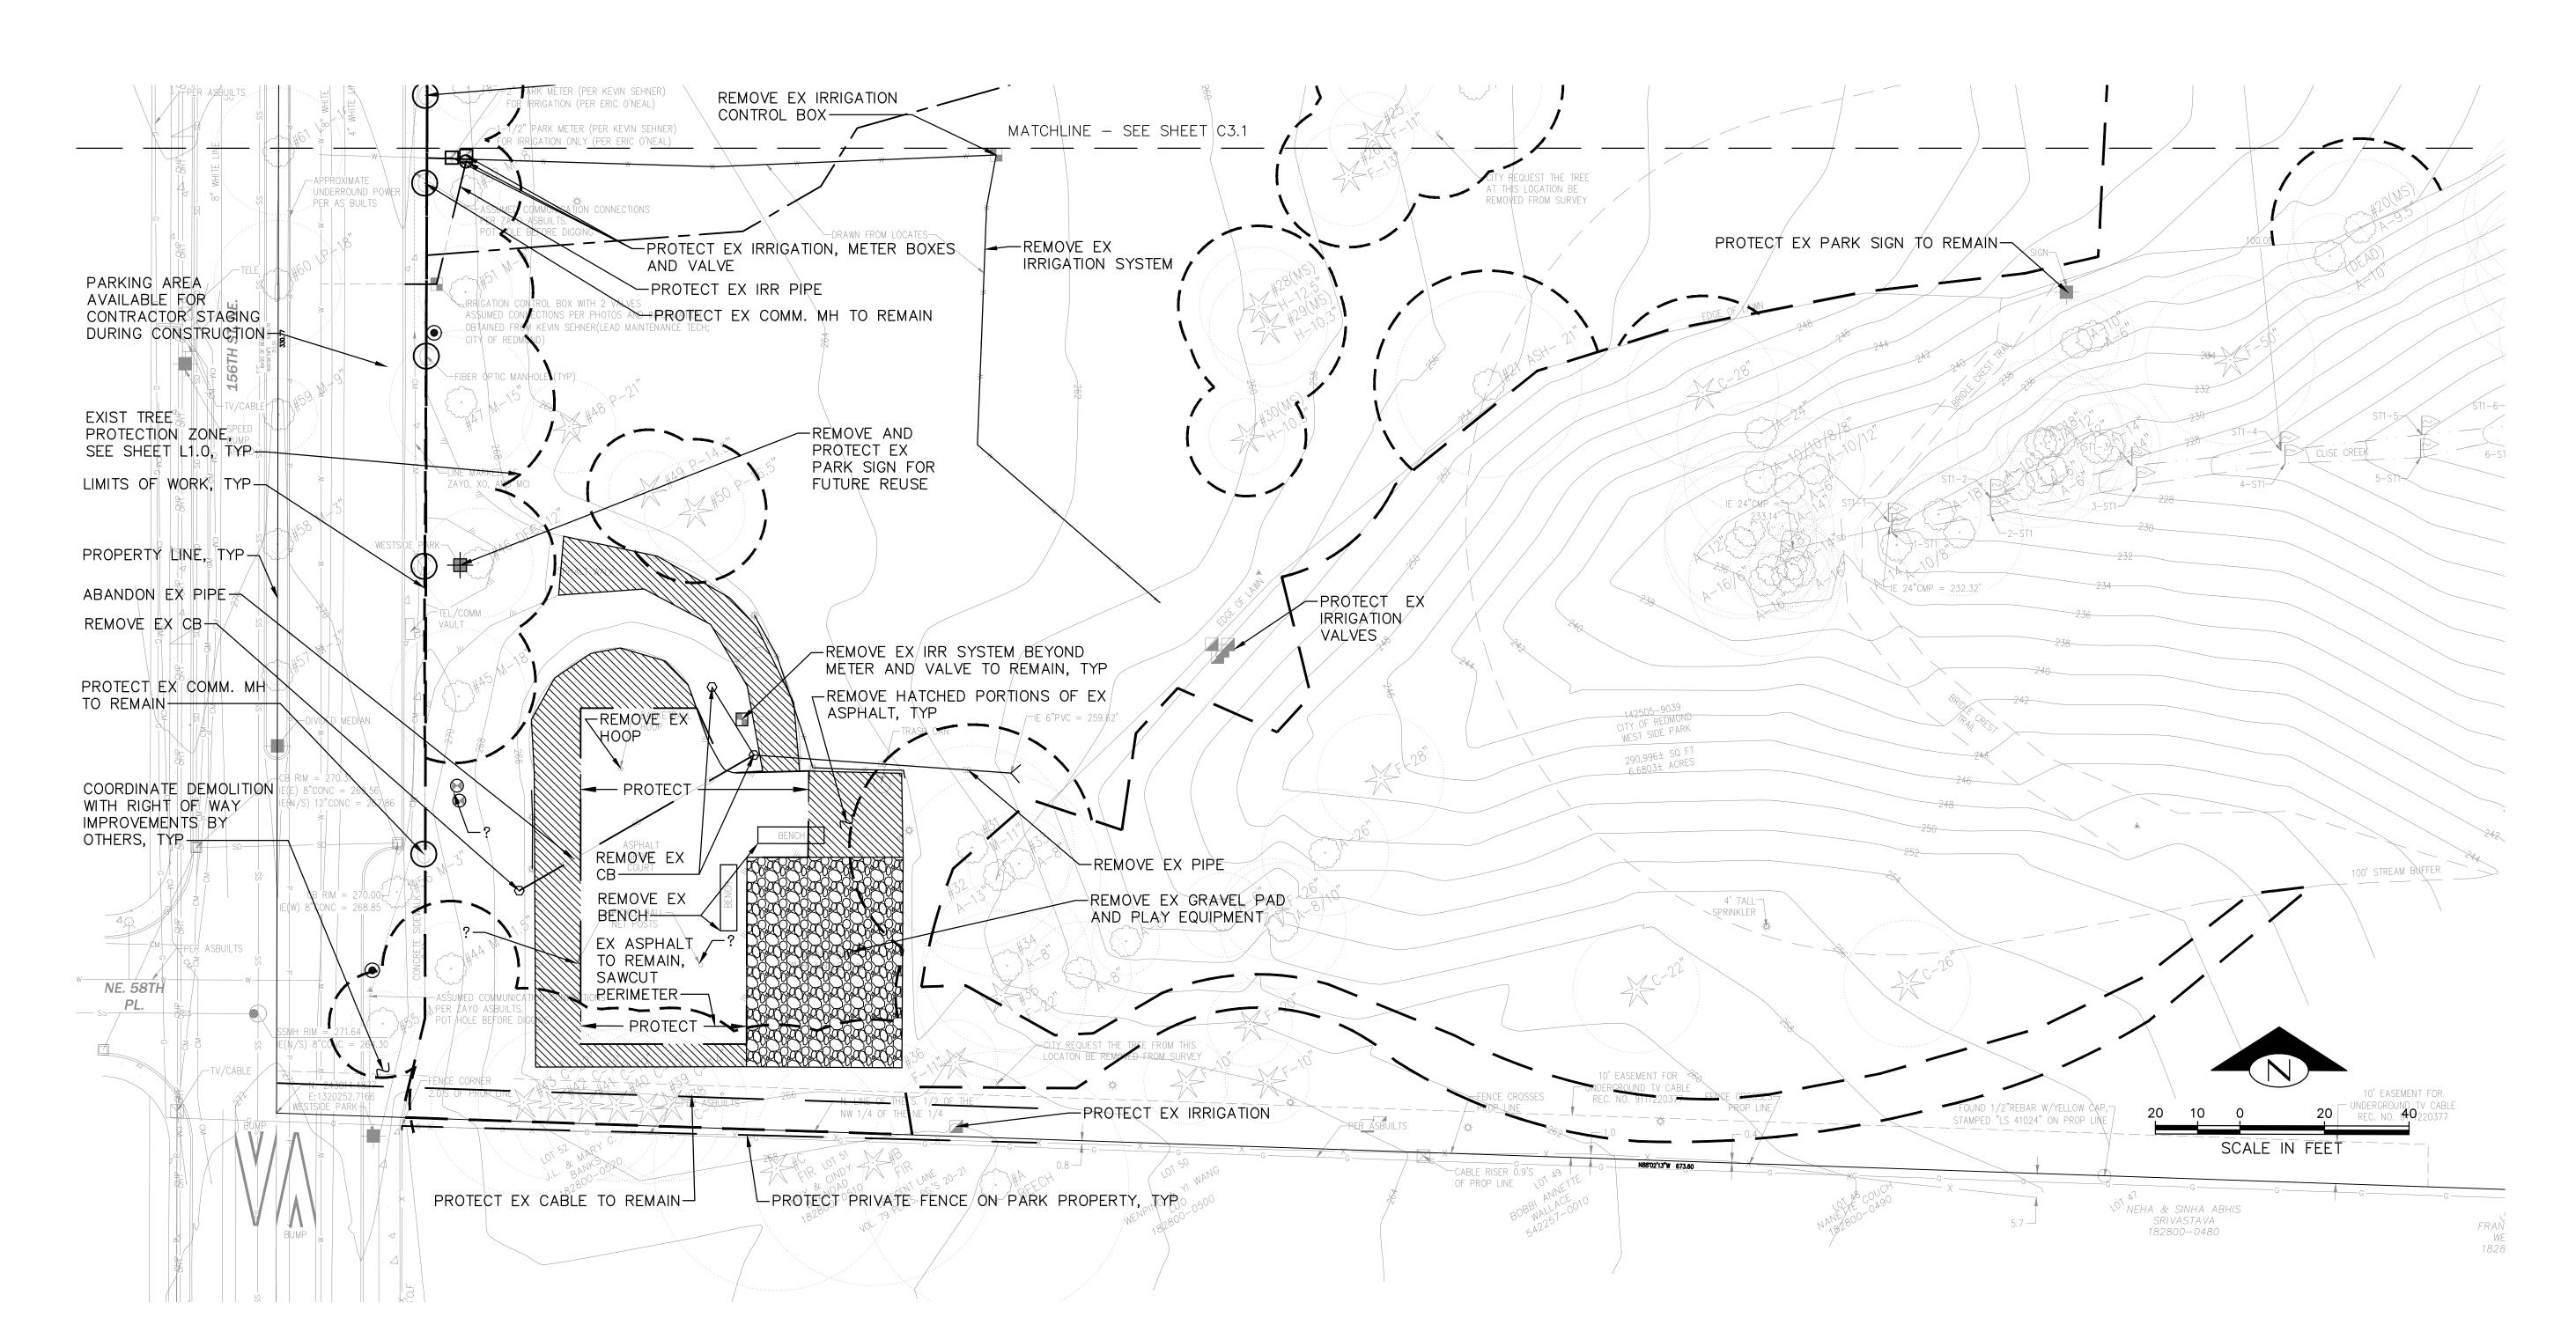


DEMOLITION NOTES

- 1. SEE SHEET C1.0 FOR GENERAL NOTES, ABBREVIATIONS AND CITY OF REDMOND STANDARD NOTES.
- 2. SEE SHEET C3.1 FOR ADDITIONAL DEMOLITION NOTES.
- 3. SEE SHEET L3.0 GRADING PLAN FOR EXTENT OF SOILS TO BE REMOVED OR AMENDED.

DEMOLITION LEGEND

OR SALVAGED

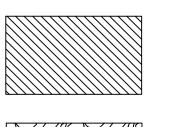

ASPHALT PAVEMENT REMOVAL

REMOVE GRAVEL AREA

Approved for Construction

Steve Flude, P.E. DATE City Engineer

THIS DEVELOPMENT SHALL BE CONSTRUCTED IN ACCORDANCE WITH THE 2020 CITY OF REDMOND STANDARD SPECIFICATIONS AND DETAILS.

oard & Vellur 115 15th Ave E. Suite 100 Seattle, WA 98112




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REDMOND WESTSIDE
RENOVATION

PARK



SSUANCES

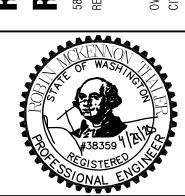DATE

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04.30.2020 SITE PLAN ENTITLEMENT

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BOARD & VELLUM PROJECT #: 2019176.00

PROJECT #: 500021924

PLOT DATE: 04.30.2020

DEMOLITION PLAN
SOUTH
C3.2


STORM DRAIN NOTES


- SEE SHEET C1.0 FOR GENERAL NOTES, ABBREVIATIONS AND CITY OF REDMOND STANDARD NOTES
- SEE SHEET C4.2 FOR A STORM DRAIN VALUE TABLE.
- GRADING AND SITE LAYOUT IS DESIGNED AND DETAILED ON OTHER PLAN SHEETS BY BOARD & VELLUM. PLEASE REFERENCE THESE SHEETS FOR ADDITIONAL INFORMATION. ELEMENTS OF THESE PLANS ARE SHOWN ON THE SD & UTILITY PLAN FOR COORDINATION AND COMPREHENSION.
- THE LIMITS OF WORK SHOWN ON THIS PLAN SHALL BE CLEARLY FLAGGED IN THE FIELD PRIOR TO CONSTRUCTION. DURING THE CONSTRUCTION PERIOD, NO DISTURBANCE BEYOND THE FLAGGED LIMITS OF WORK SHALL BE PERMITTED. THE FLAGGING SHALL BE MAINTAINED FOR THE DURATION OF CONSTRUCTION.
- REFERENCE THE TREE PRESERVATION PLAN FOR ALL WORK WITHIN TREE PROTECTION ZONE.
- ALL STORMWATER AND UTILITY STRUCTURES MUST HAVE NON SKID LIDS.
- ALL DISPERSAL AREAS MUST BE UNDISTURBED NATIVE SOILS OR AMENDED SOILS THAT MEET COR BMP T5.13.
- ROCK ENERGY DISSIPATOR SHALL BE FIELD LOCATED TO PROVIDE PROTECTION FOR LOW AND HIGH DESIGN FLOWS. ROCK SHALL BE 2-IN TO 8-IN RIPRAP WITH A MINIMUM THICKNESS OF 1-FOOT. FIELD LOCATE ROCKS TO DIRECT FLOW PERPENDICULAR TO CONTOURS.
- UNDERDRAINS SHALL BE 6" DIAMETER PERFORATED PVC PER WSDOT STANDARD SPECIFICATION 9-05.2(6).
- 10. EXISTING STORM DRAIN PIPE UNDER SPORT COURT TO REMAIN WILL BE ABANDONED IN PLACE. EXISTING STORM DRAIN OUTSIDE OF THIS AREA WILL BE REMOVED. SEE DEMO PLAN SOUTH, SHEET C3.2 FOR ADDITIONAL INFORMATION.

ONSITE STORMWATER MANAGEMENT NOTES

- ONSITE STORMWATER MANAGEMENT (OSM) IS REQUIRED FOR THIS PROJECT BY THE CITY OF REDMOND.
- OSM IS MET WITH THE FOLLOWING BEST MANAGEMENT PRACTICES (BMPS):
 - 2.1. AMENDED SOILS IN ALL AREAS OF NEW AND REPLACED LANDSCAPE.
 - BIORETENTION FACILITY WITH UNDERDRAINS FOR SPORTS COURTS, PICNIC SHELTER AND ADJACENT IMPERVIOUS PATHS.
 - SHEET FLOW DISPERSAL FOR PATHS.
 - CONCENTRATED FLOW DIPSERSAL FOR PLAY FIELD.
 - IN ADDITION TO THE BMPS NOTED ABOVE, SIGNIFICANT EXISTING TREES AS WELL AS PROPOSED TREES PROVIDE ADDITIONAL BENEFIT.
- ADDITIONAL OSM INFORMATION AND DOCUMENTATION IS LOCATED IN THE STORM DRAIN REPORT.

STORM DRAIN LEGEND

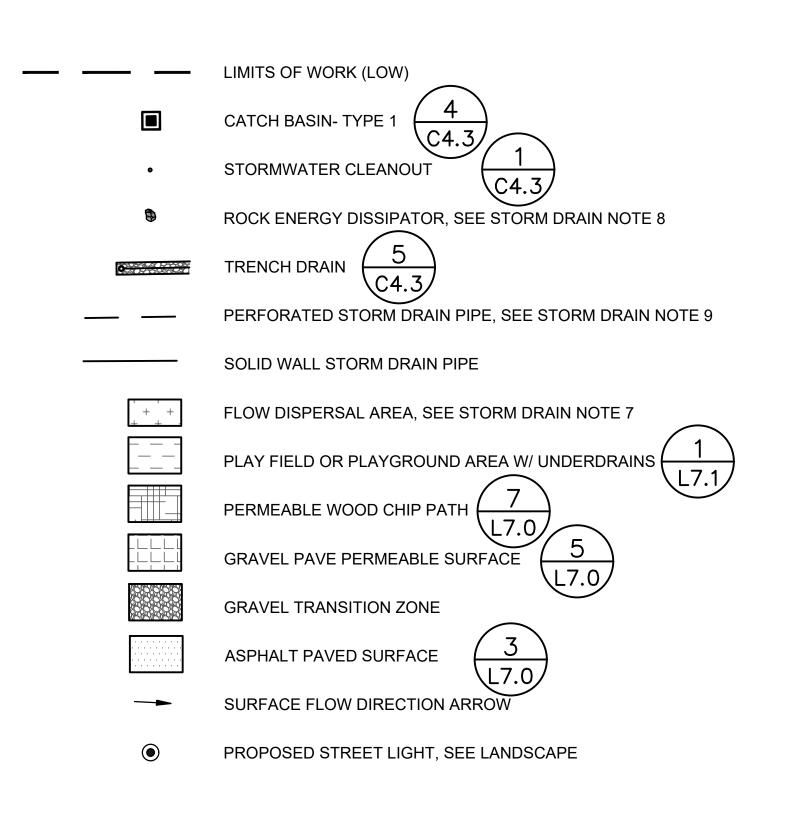

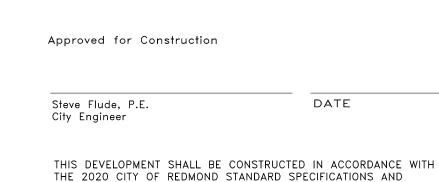


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WESTSIDE 1 REDMOND

PARK



ISSUANCES DESCRIPTION

DATE

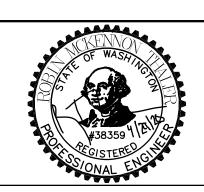
02.26.2020 30% PLANS 04.20.2020 60% PLANS

04.30.2020 SITE PLAN ENTITLEMEN

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STORM DRAIN & **UTILITY PLAN NORTH** C4.1

SHEET NO.: 15 OF 35

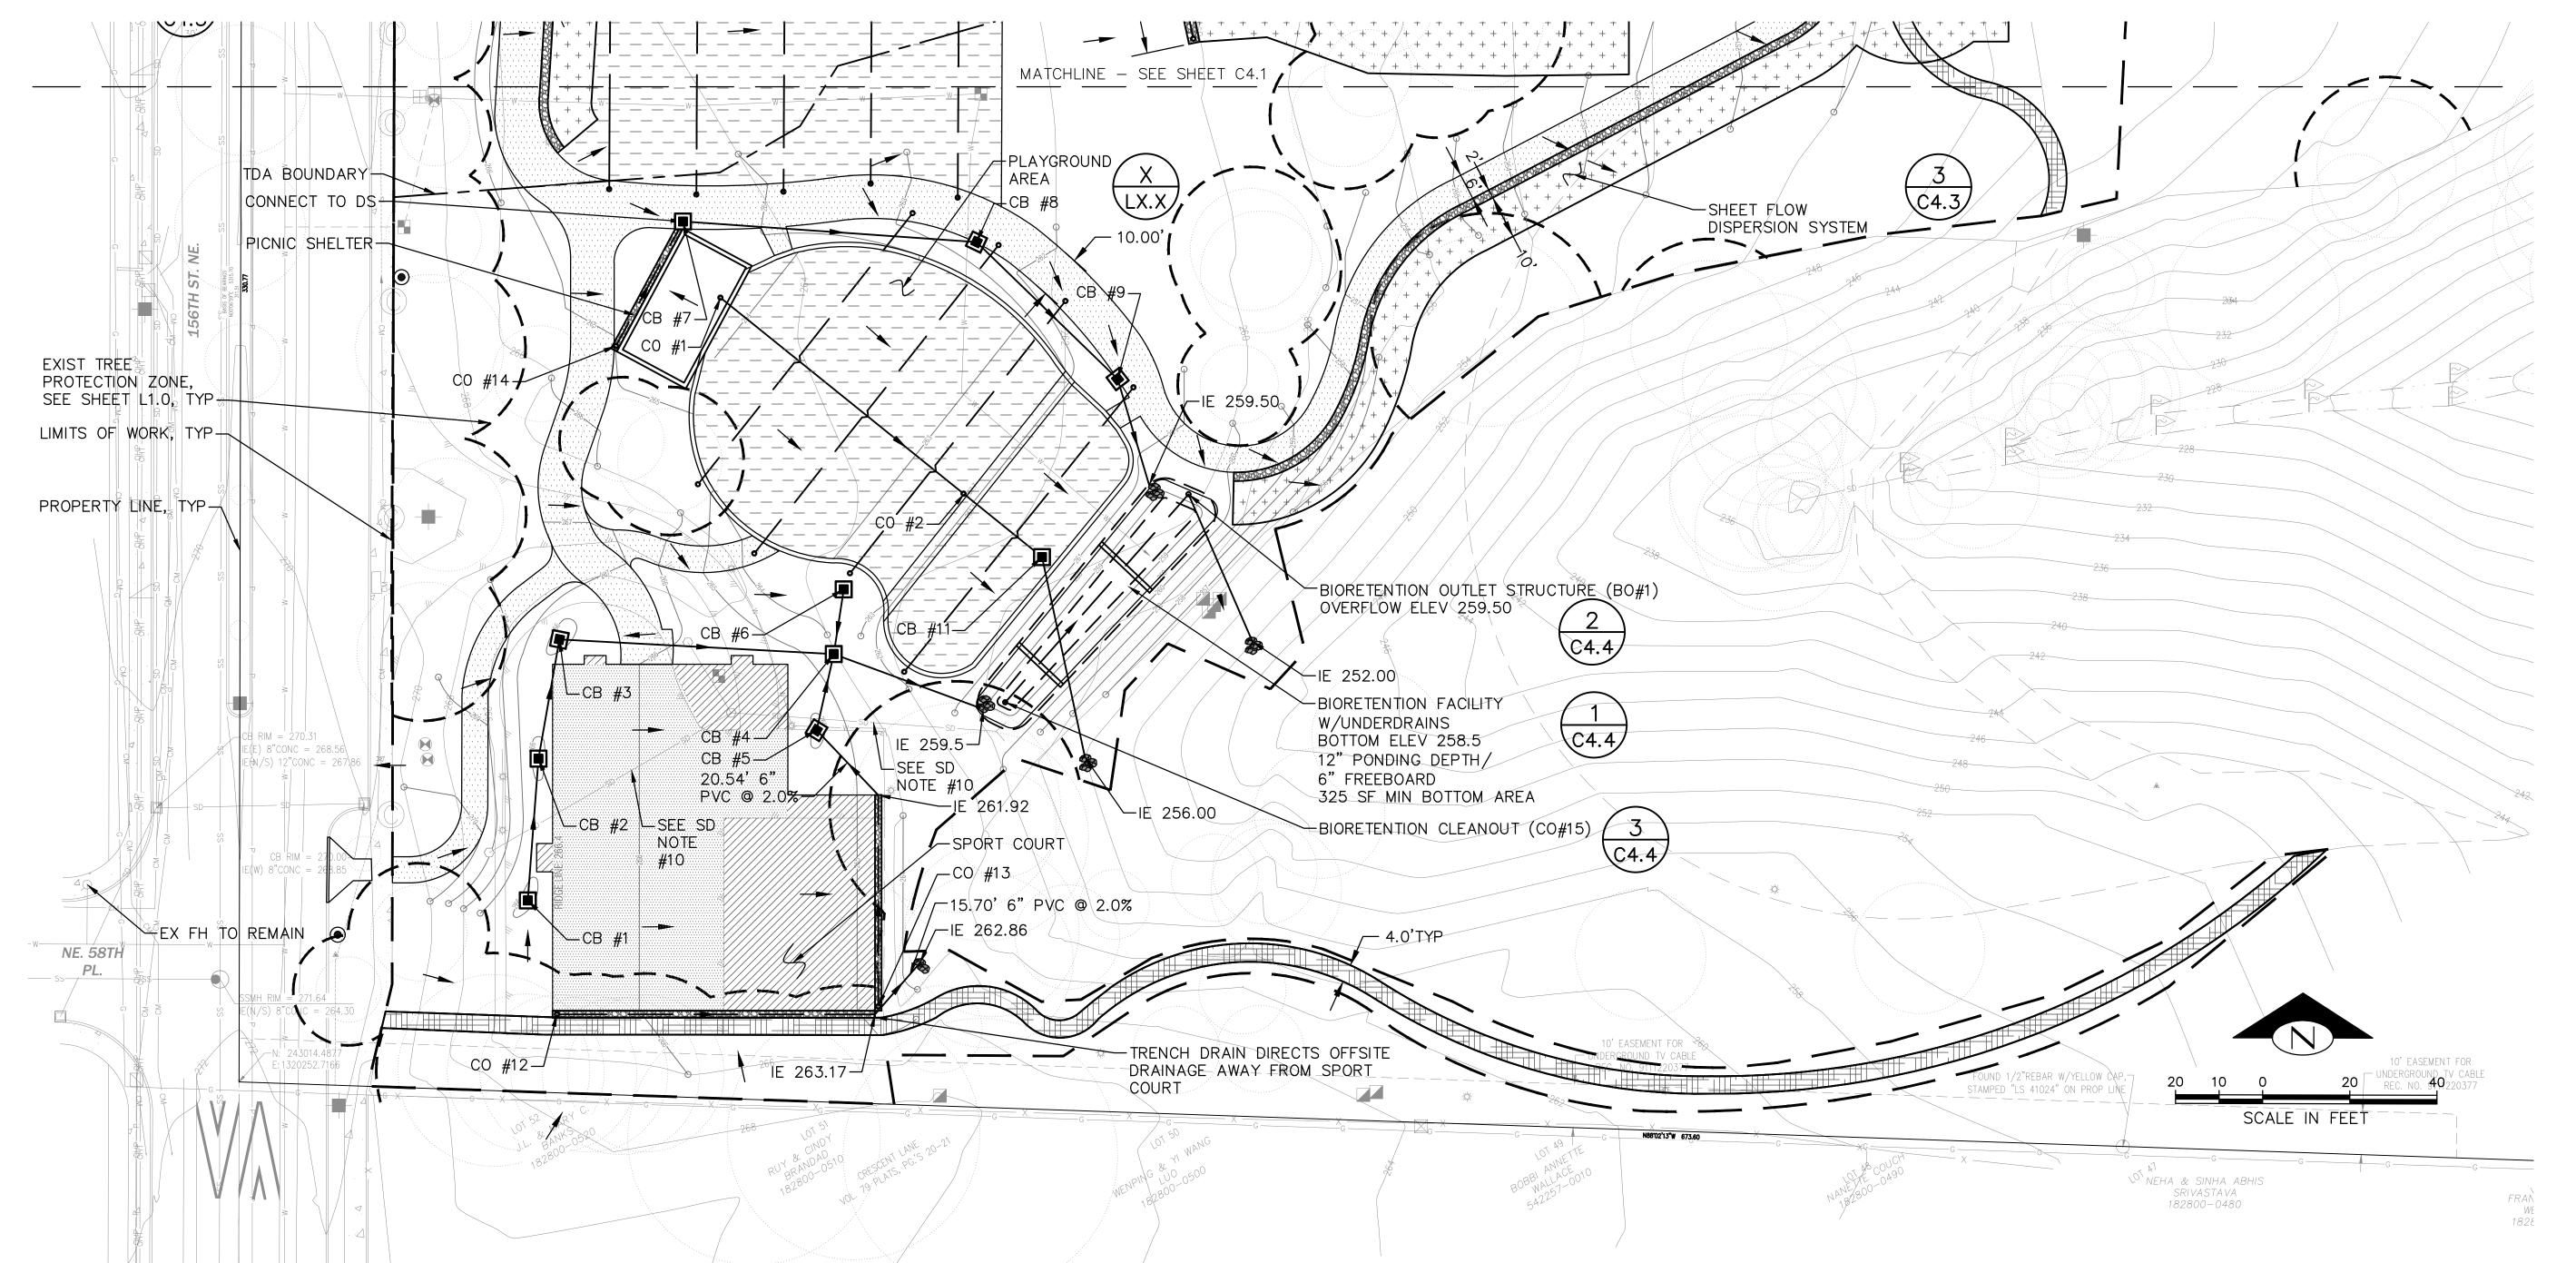

STORM DRAIN VALUE TABLE

	and the state of t					PIPE	-	PIPE	
	A CONTRACTOR OF THE PROPERTY O	000000000000000000000000000000000000000		**************************************		TYPE	PIPE DIAM.	LENGTH OUT	PIPE SLOPE
ID	RIM	IE IN	IE OUT	TYPE	FRAME AND GRATE	OUT	OUT (IN)	(FT)	OUT
BO#1	259.50	255.19	253.00	PER PLANS	PER PLANS	PVC	12	36.84	2.71%
			oonnomen Tolonoon voorining dat die verste vooring dat de vooring dat de vooring dat de vooring dat de vooring de verste vooring dat de vooring dat de vooring de verste vooring dat de vooring dat de vooring de verste vooring de verste vooring dat de vooring de verste vooring de ver						
CB#1	265.90	NA	263.40	TYPE 1	VANED GRATE	PVC	6	32.64	2.00%
CB#2	265.90	262.75	262.75	TYPE 1	VANED GRATE	PVC	6	27.76	2.00%
CB#3	265.60	262.19	262.19	TYPE 1	VANED GRATE	PVC	6	63.05	3.16%
CB#4	264.00	260.20	260.03	TYPE 1	SOLID	DI	8	35.78	1.49%
CB#5	264.90	261.50	261.50	TYPE 1	VANED GRATE	PVC	6	17.92	7.25%
CB#6	263.00	NA	260.50	TYPE 1	VANED GRATE	PVC	6	15.01	2.00%
CB#7	264.50	NA	262.00	TYPE 1	VANED GRATE	DI	6	67.54	1.90%
CB#8	262.39	260.72	260.72	TYPE 1	VANED GRATE	DI	6	45.13	1.90%
CB#9	261.60	259.86	259.86	TYPE 1	VANED GRATE	DI	6	25.4	1.42%
CB#10	260.00	256.90	256.90	TYPE 1	SOLID LOCKING	PVC	6 PERF	NA	1.00%
CB#11	261.10	257.50	257.50	TYPE 1	SOLID LOCKING	PVC	6	46.99	3.19%
CO#1	264.50	262.00	262.00	STD	SOLID	PVC	6	71.69	4.18%
CO#2	262.70	259.00	259.00	STD	SOLID	PVC	6	23.13	6.49%
CO#11	264.30	NA	261.20	STD	SOLID	PVC	6	129.37	3.32%
CO#12	266.40	NA	263.90	STD	SOLID	PVC	6 PERF	73	1.00%
CO#13	264.90	NA	262.40	STD	SOLID	PVC	6 PERF	48.5	1.00%
CO#14	265.00	NA	262.50	STD	SOLID	PVC	6 PERF	32.47	1.54%
CO#15	260.00	NA	255.83	PER PLANS	PER PLANS	PVC	6 PERF	63.62	1.00%
	000000000000000000000000000000000000000			**************************************					

GENERAL NOTES

1. SEE SHEET C1.0 FOR GENERAL NOTES, ABBREVIATIONS AND CITY OF REDMOND STANDARD PLANS.

STORM DRAIN NOTES

- 1. SEE SHEET C4.1
- SEE SHEET C4.1 FOR STORM DRAIN LEGEND

ONSITE SW MANAGEMENT (OSM) NOTES

1. SEE SHEET C4.1

Approved for Construction

Steve Flude, P.E. City Engineer


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DATE





ID WESTSIDE PARK

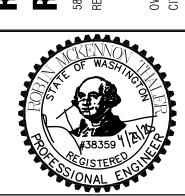

DATE 02.26.2020 30% PLANS

04.20.2020 60% PLANS 04.30.2020 SITE PLAN ENTITLEMENT

DESCRIPTION

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500021924 PLOT DATE: 04.30.2020


STORM DRAIN & **UTILITY PLAN SOUTH**

C4.2

16 of 35

DRAINAGE OVERVIEW NOTES

- 1. SEE SHEET C1.0 FOR GENERAL NOTES, ABBREVIATIONS AND CITY OF REDMOND STANDARD NOTES.
- 2. THIS DRAINAGE AREAS PLAN IS INCLUDED FOR REFERENCE ONLY AND SHALL NOT BE USED FOR CONSTRUCTION.

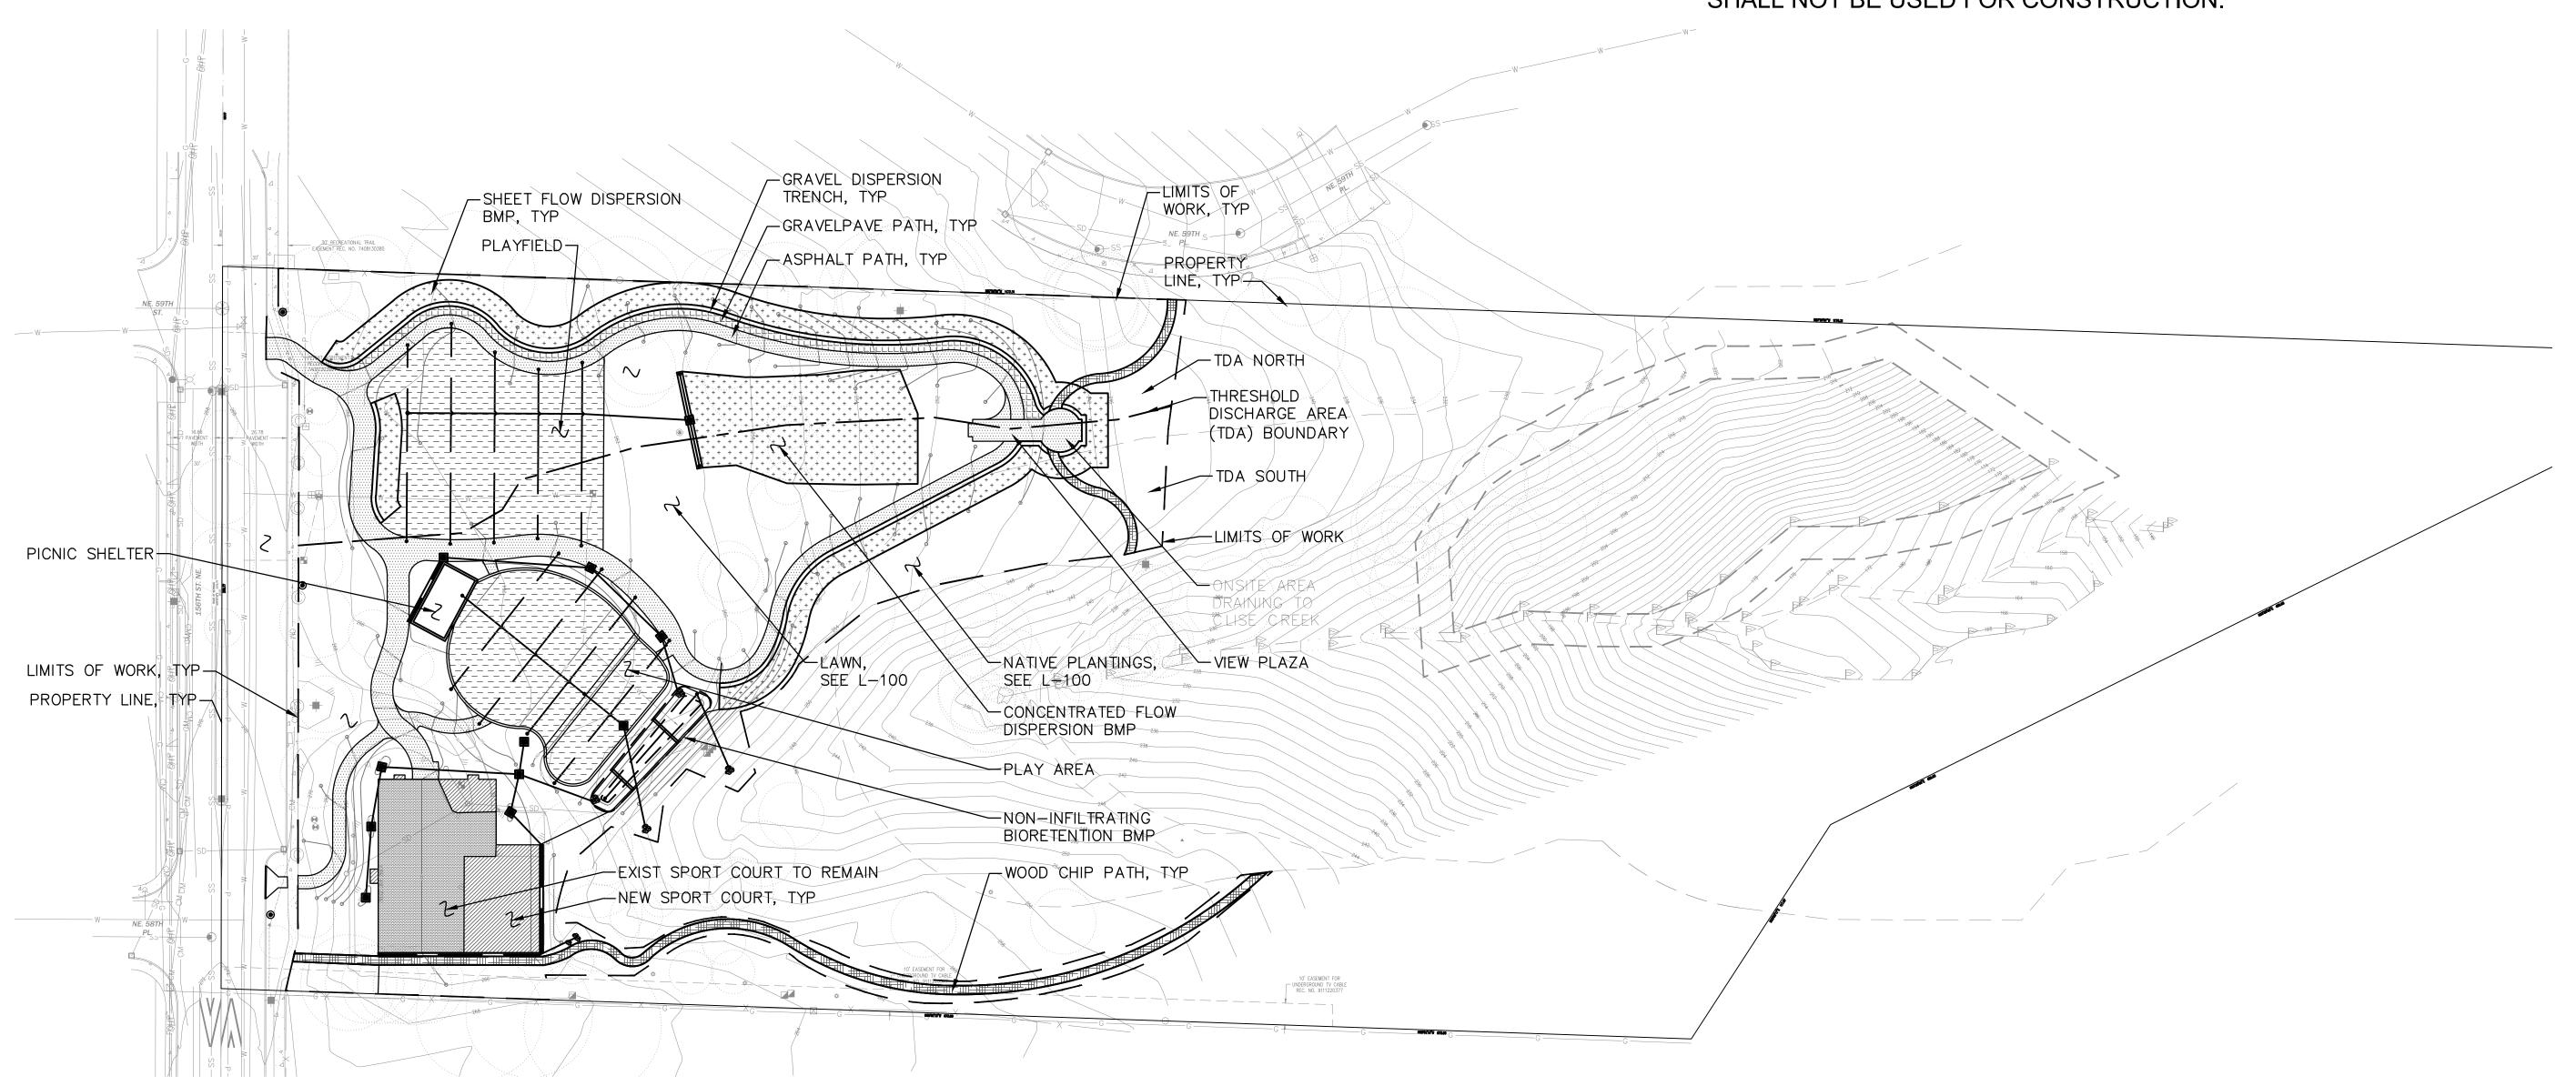

	TOTA	L SITE	TDA S	TDA SOUTH		IORTH
	SF	AC	SF	AC	SF	AC
LIMITS OF WORK	91,584	2.102	59,086	1.356	32,498	0.746
EXISTING AREAS						
Hard Surfaces (Walkways & Sport Court)	7,858	0.180	7,858	0.180	0	0.000
Pervious (Lawn/Landscaping)	83,726	1.922	51,228	1.176	32,498	0.746
PROPOSED AREAS						
PROPOSED ROOF AREAS (Picnic Shelter)	576	0.013	576	0.013	0	0.000
TOTAL PROPOSED NON-ROOF HARD SURFACES	12,528	0.288	8,110	0.186	4,418	0.101
Sport Court	2,032	0.047	2,032	0.047	0	0.000
Asphalt Paths	8,337	0.191	4,783	0.110	3,554	0.082
View Plaza	680	0.016	680	0.016	0	0.000
Gravel Dispersion Trenches	1,479	0.034	615	0.014	864	0.020
TOTAL PROPOSED PERVIOUS SURFACES	75,185	1.726	47,105	1.081	28,080	0.645
Permeable Play Area with Underdrains	6,513	0.150	6,513	0.150	0	0.000
Permeable Gravel Pave Paths	1,460	0.034	0	0.000	1,460	0.034
Permeable Wood Chip Paths	2,469	0.057	2,145	0.049	324	0.007
Playfield (Fertilized Lawn with Underdrains)	8,738	0.201	1,570	0.036	7,168	0.165
Fertilized Lawn	19,618	0.450	12,310	0.283	7,308	0.168
Native Plantings	36,387	0.835	24,567	0.564	11,820	0.271
TOTAL NEW PLUS REPLACED HARD SURFACES	13,104	0.301	8,686	0.199	4,418	0.101
EXISTING HARD SURFACE TO REMAIN (Sport Court)	3,295	0.076	3,295	0.076	0	0.000
TOTAL PERVIOUS SURFACING MATERIALS	10,442	0.240	8,658	0.199	1,784	0.041
TOTAL LANDSCAPING	64,743	1.486	38,447	0.883	26,296	0.604

Approved for Construction

Steve Flude, P.E. City Engineer

THIS DEVELOPMENT SHALL BE CONSTRUCTED IN ACCORDANCE WITH THE 2020 CITY OF REDMOND STANDARD SPECIFICATIONS AND DETAILS.

DATE

Board & Vellum
115 15th Ave E. Suite 100 Seattle, WA 98112





REDMOND WESTSIDE | RENOVATION

PARK



ISSUANCES

 DATE
 DESCRIPTION

 02.26.2020
 30% PLANS

 04.20.2020
 60% PLANS

04.30.2020 SITE PLAN ENTITLEMENT


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BOARD & VELLUM PROJECT #: PROJECT #:	2019176.00 500021924
PLOT DATE:	04.30.2020


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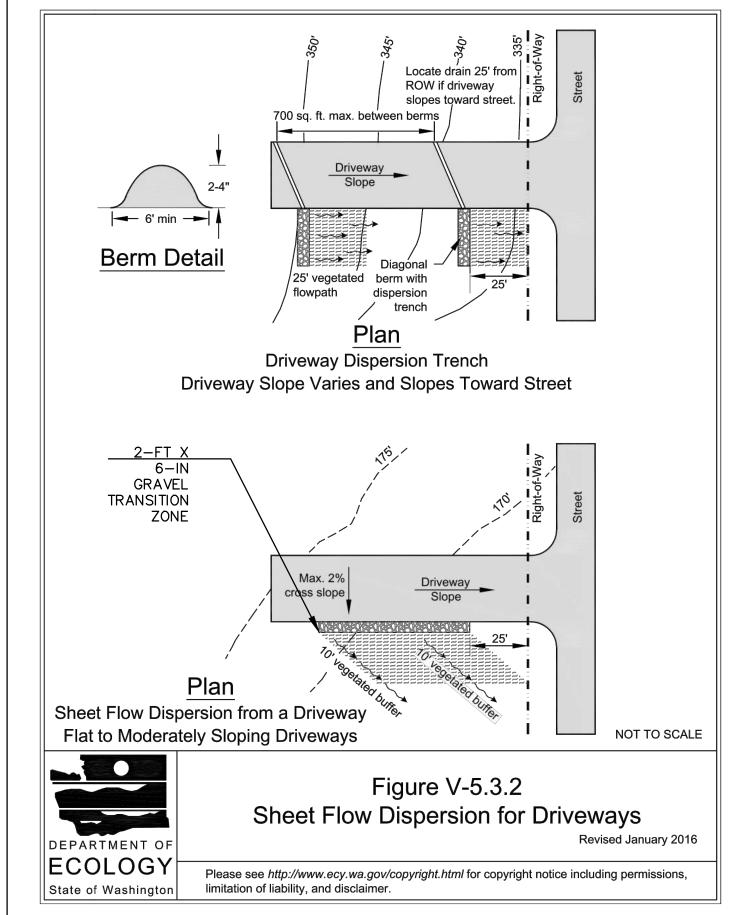
DRAINAGE AREAS

C4.3

SHEET NO.: 17 OF 35



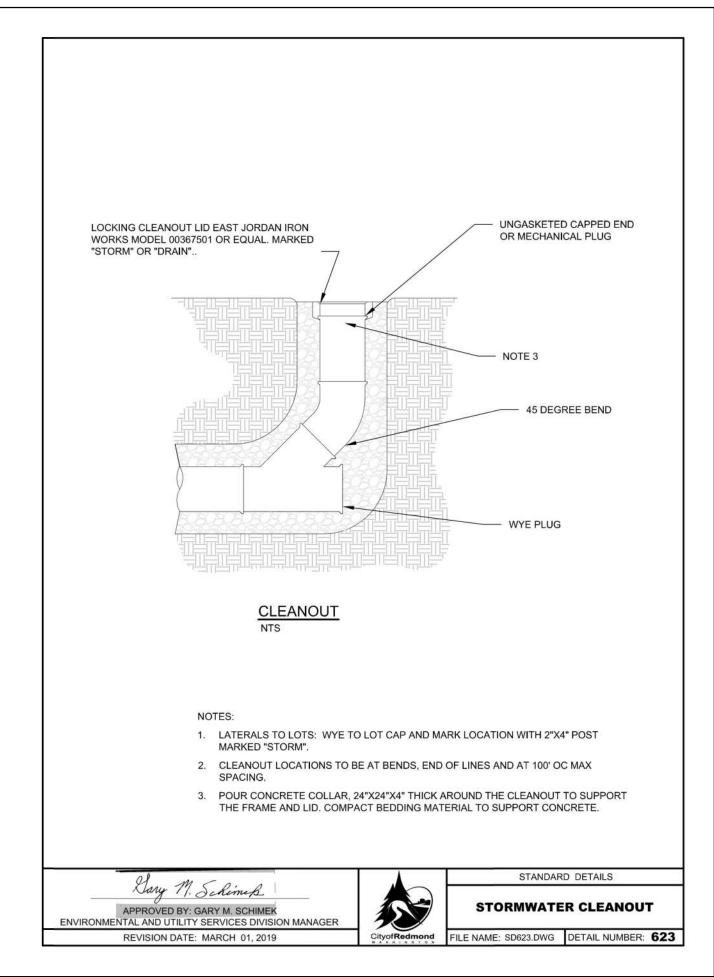

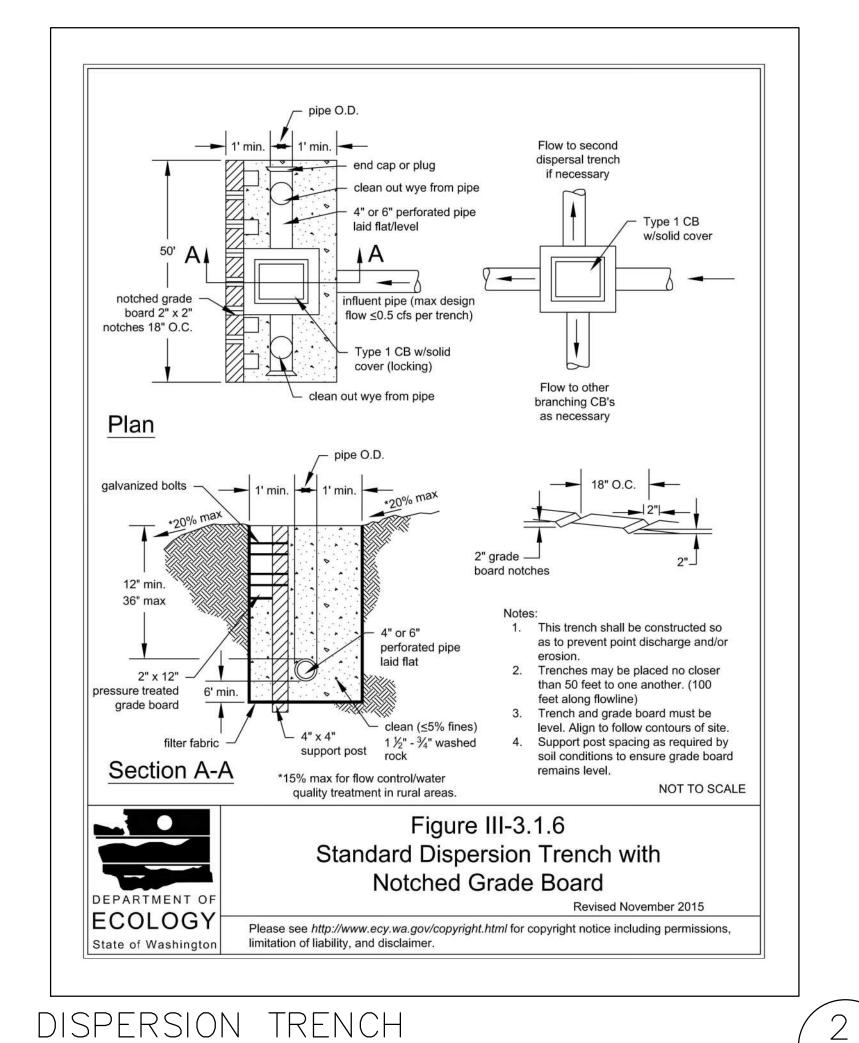

SHEET FLOW DISPERSION SYSTEM C4.1,C4.2

STORMWATER CLEANOUT NTS

#3 BAR EACH CORNER

#3 BAR HOOP

#3 BAR EACH WAY

NTS

C4.1,C4.2

NTS

NOTES 1. As acceptable alternatives to the rebar shown in the PRECAST BASE SECTION, fibers (placed according to the Standard Specifications), or wire mesh having a minimum area of 0.12 square inches per foot shall be used with the minimum required rebar shown in the ALTERNATIVE PRECAST BASE SECTION. Wire mesh shall not be placed in the 2. The knockout diameter shall not be greater than 20" (in). Knockouts shall

have a wall thickness of 2" (in) minimum to 2.5" (in) maximum. Provide a 1.5" (in) minimum gap between the knockout wall and the outside of the pipe. After the pipe is installed, fill the gap with joint mortar in accordance with Standard Specification Section 9-04.3.

3. The maximum depth from the finished grade to the lowest pipe invert shall be 5' (ft).

4. The frame and grate may be installed with the flange down, or integrally cast into the adjustment section with flange up.

5. The Precast Base Section may have a rounded floor, and the walls may be sloped at a rate of 1: 24 or steeper.

6. The opening shall be measured at the top of the **Precast Base Section**. 7. All pickup holes shall be grouted full after the basin has been placed.

- SUITABLE NATIVE BACKFILL MATERIAL SIDEWALK GRAVEL BACKFILL FOR DRYWELLS PER SECTION 9-03.12(5) GEOTEXTILE PER SPEC 9-33.2(1) TABLE 3, SOIL STABILIZATION, NONWOVEN. 6" PERF PVC DRAIN PIPE CL HOLES GRAVEL BACKFILL FOR PIPE ZONE BEDDING PER SECTION 9-30.12(3) PERF-DRAIN TIGHT-LINE TRENCH DRAIN NTS

SEE DETAIL 623 FOR STORMWATER CLEANOUT DETAIL

BE PRIVATE SYSTEM

APPROVED BY: GARY M. SCHIMEK

ENVIRONMENTAL AND UTILITY SERVICES DIVISION MANAGER

REVISION DATE: MARCH 01, 2020

2. FRENCH DRAINS BEHIND SIDEWALK REQUIRED IN ALL CUT SITUATIONS AND AT THE BASE OF SLOPES


3. FRENCH DRAINS BEHIND SIDEWALK SHALL NOT BE LOCATED

WITHIN RIGHT-OF-WAY OR PUBLIC EASEMENT, THEY SHALL

Approved for Construction

THIS DEVELOPMENT SHALL BE CONSTRUCTED IN ACCORDANCE WITH THE 2020 CITY OF REDMOND STANDARD SPECIFICATIONS AND


DATE

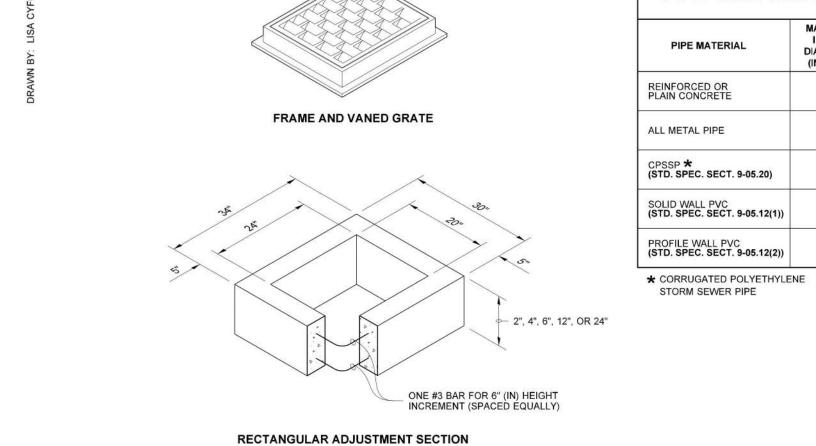

#3 BAR (TYP.)

CATCH BASIN

PIPE ALLOWANCES DIAMETER (INCHES)

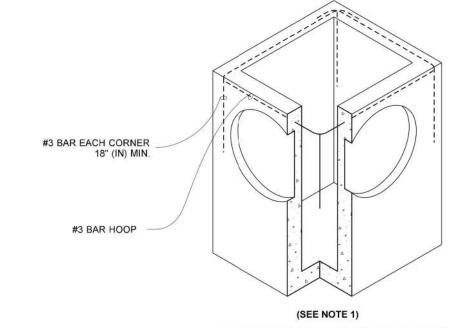

ALTERNATIVE PRECAST BASE SECTION

CATCH BASIN TYPE 1 STANDARD PLAN B-5.20-02 SHEET 1 OF 1 SHEET

APPROVED FOR PUBLICATION STATE DESIGN ENGINEER Washington State Department of Transportation

Steve Flude, P.E. City Engineer

STANDARD DETAILS

FRENCH DRAIN

FILE NAME: SD621.DWG DETAIL NUMBER: 621


MAYFLY ENGINEERING + DESIGN, PLL www.mayflyeng.com | v 206.935.5356 5042 49th avenue sw seattle, wa 98136

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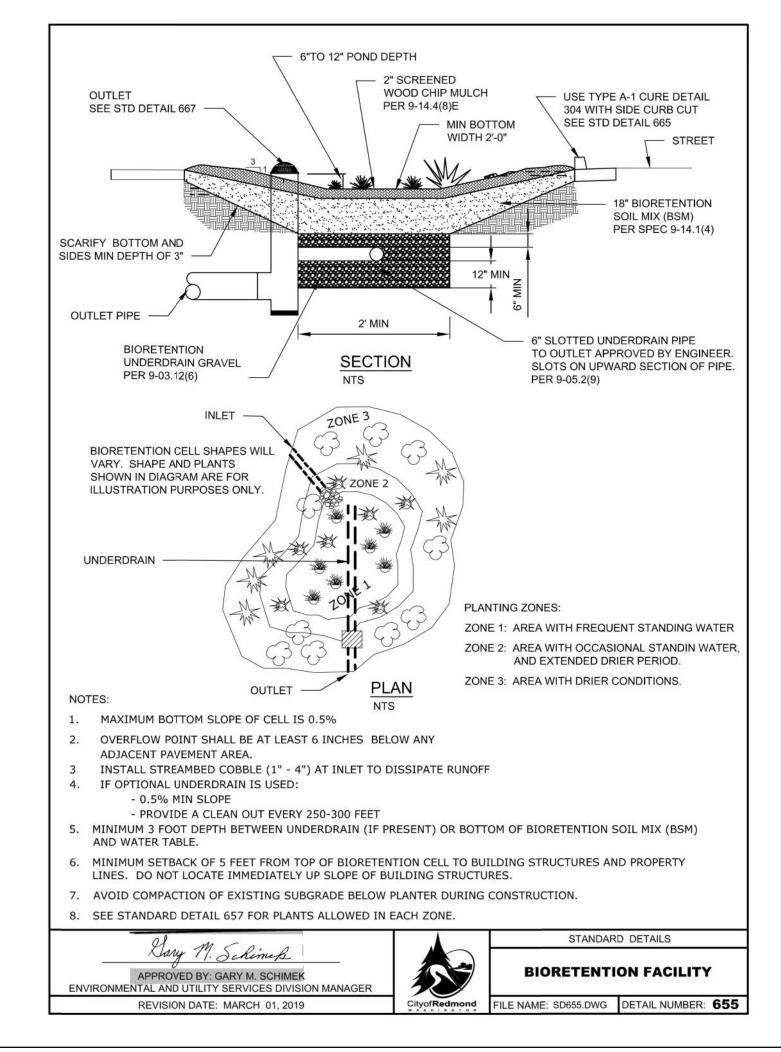
DATE DESCRIPTION 02.26.2020 30% PLANS 04.20.2020 60% PLANS


04.30.2020 SITE PLAN ENTITLEMENT

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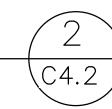
STORM DRAIN **DETAILS 1**


18 of 35

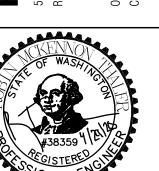

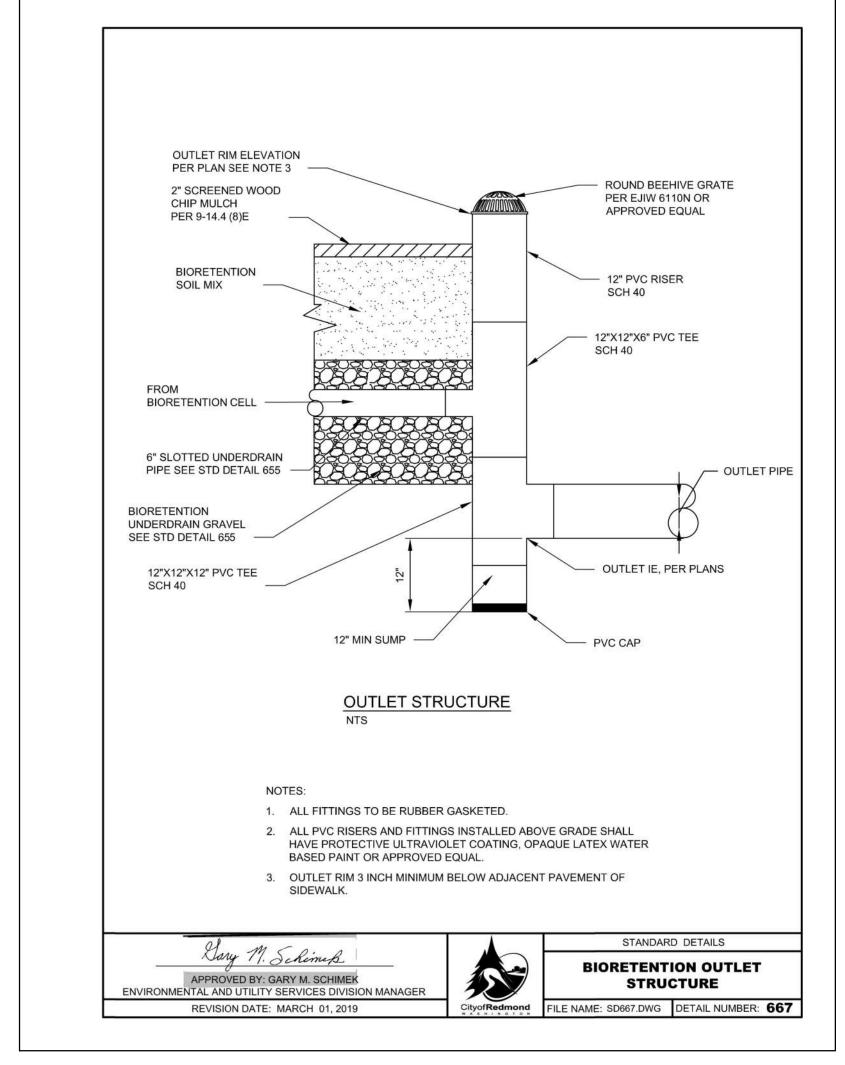

BIORETENTION OUTLET STRUCTURE




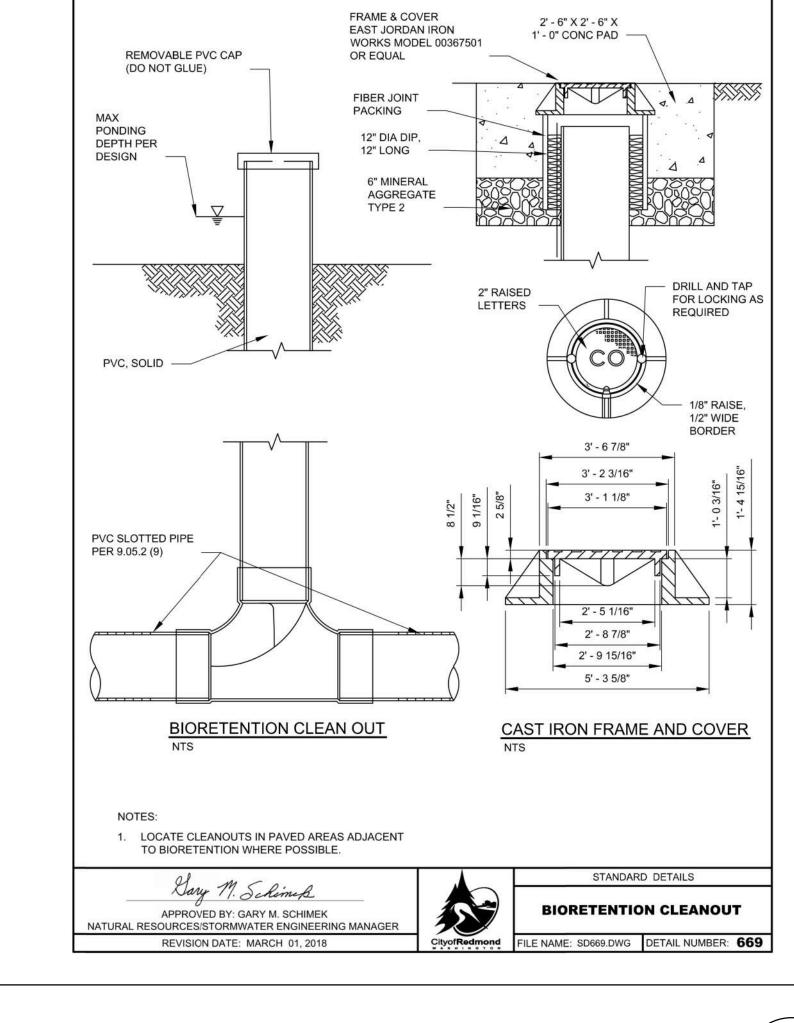

BIORETENTION CLEANOUT

REDMOND RENOVATION

WESTSIDE ION

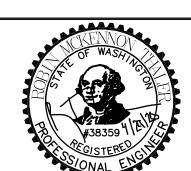

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500021924 PROJECT #: 04.30.2020 PLOT DATE:

> SHEET: **STORM DRAIN DETAILS 2**

SHEET NO.:

19 of **35**


Steve Flude, P.E. City Engineer

THIS DEVELOPMENT SHALL BE CONSTRUCTED IN ACCORDANCE WITH THE 2020 CITY OF REDMOND STANDARD SPECIFICATIONS AND

DATE



Approved for Construction

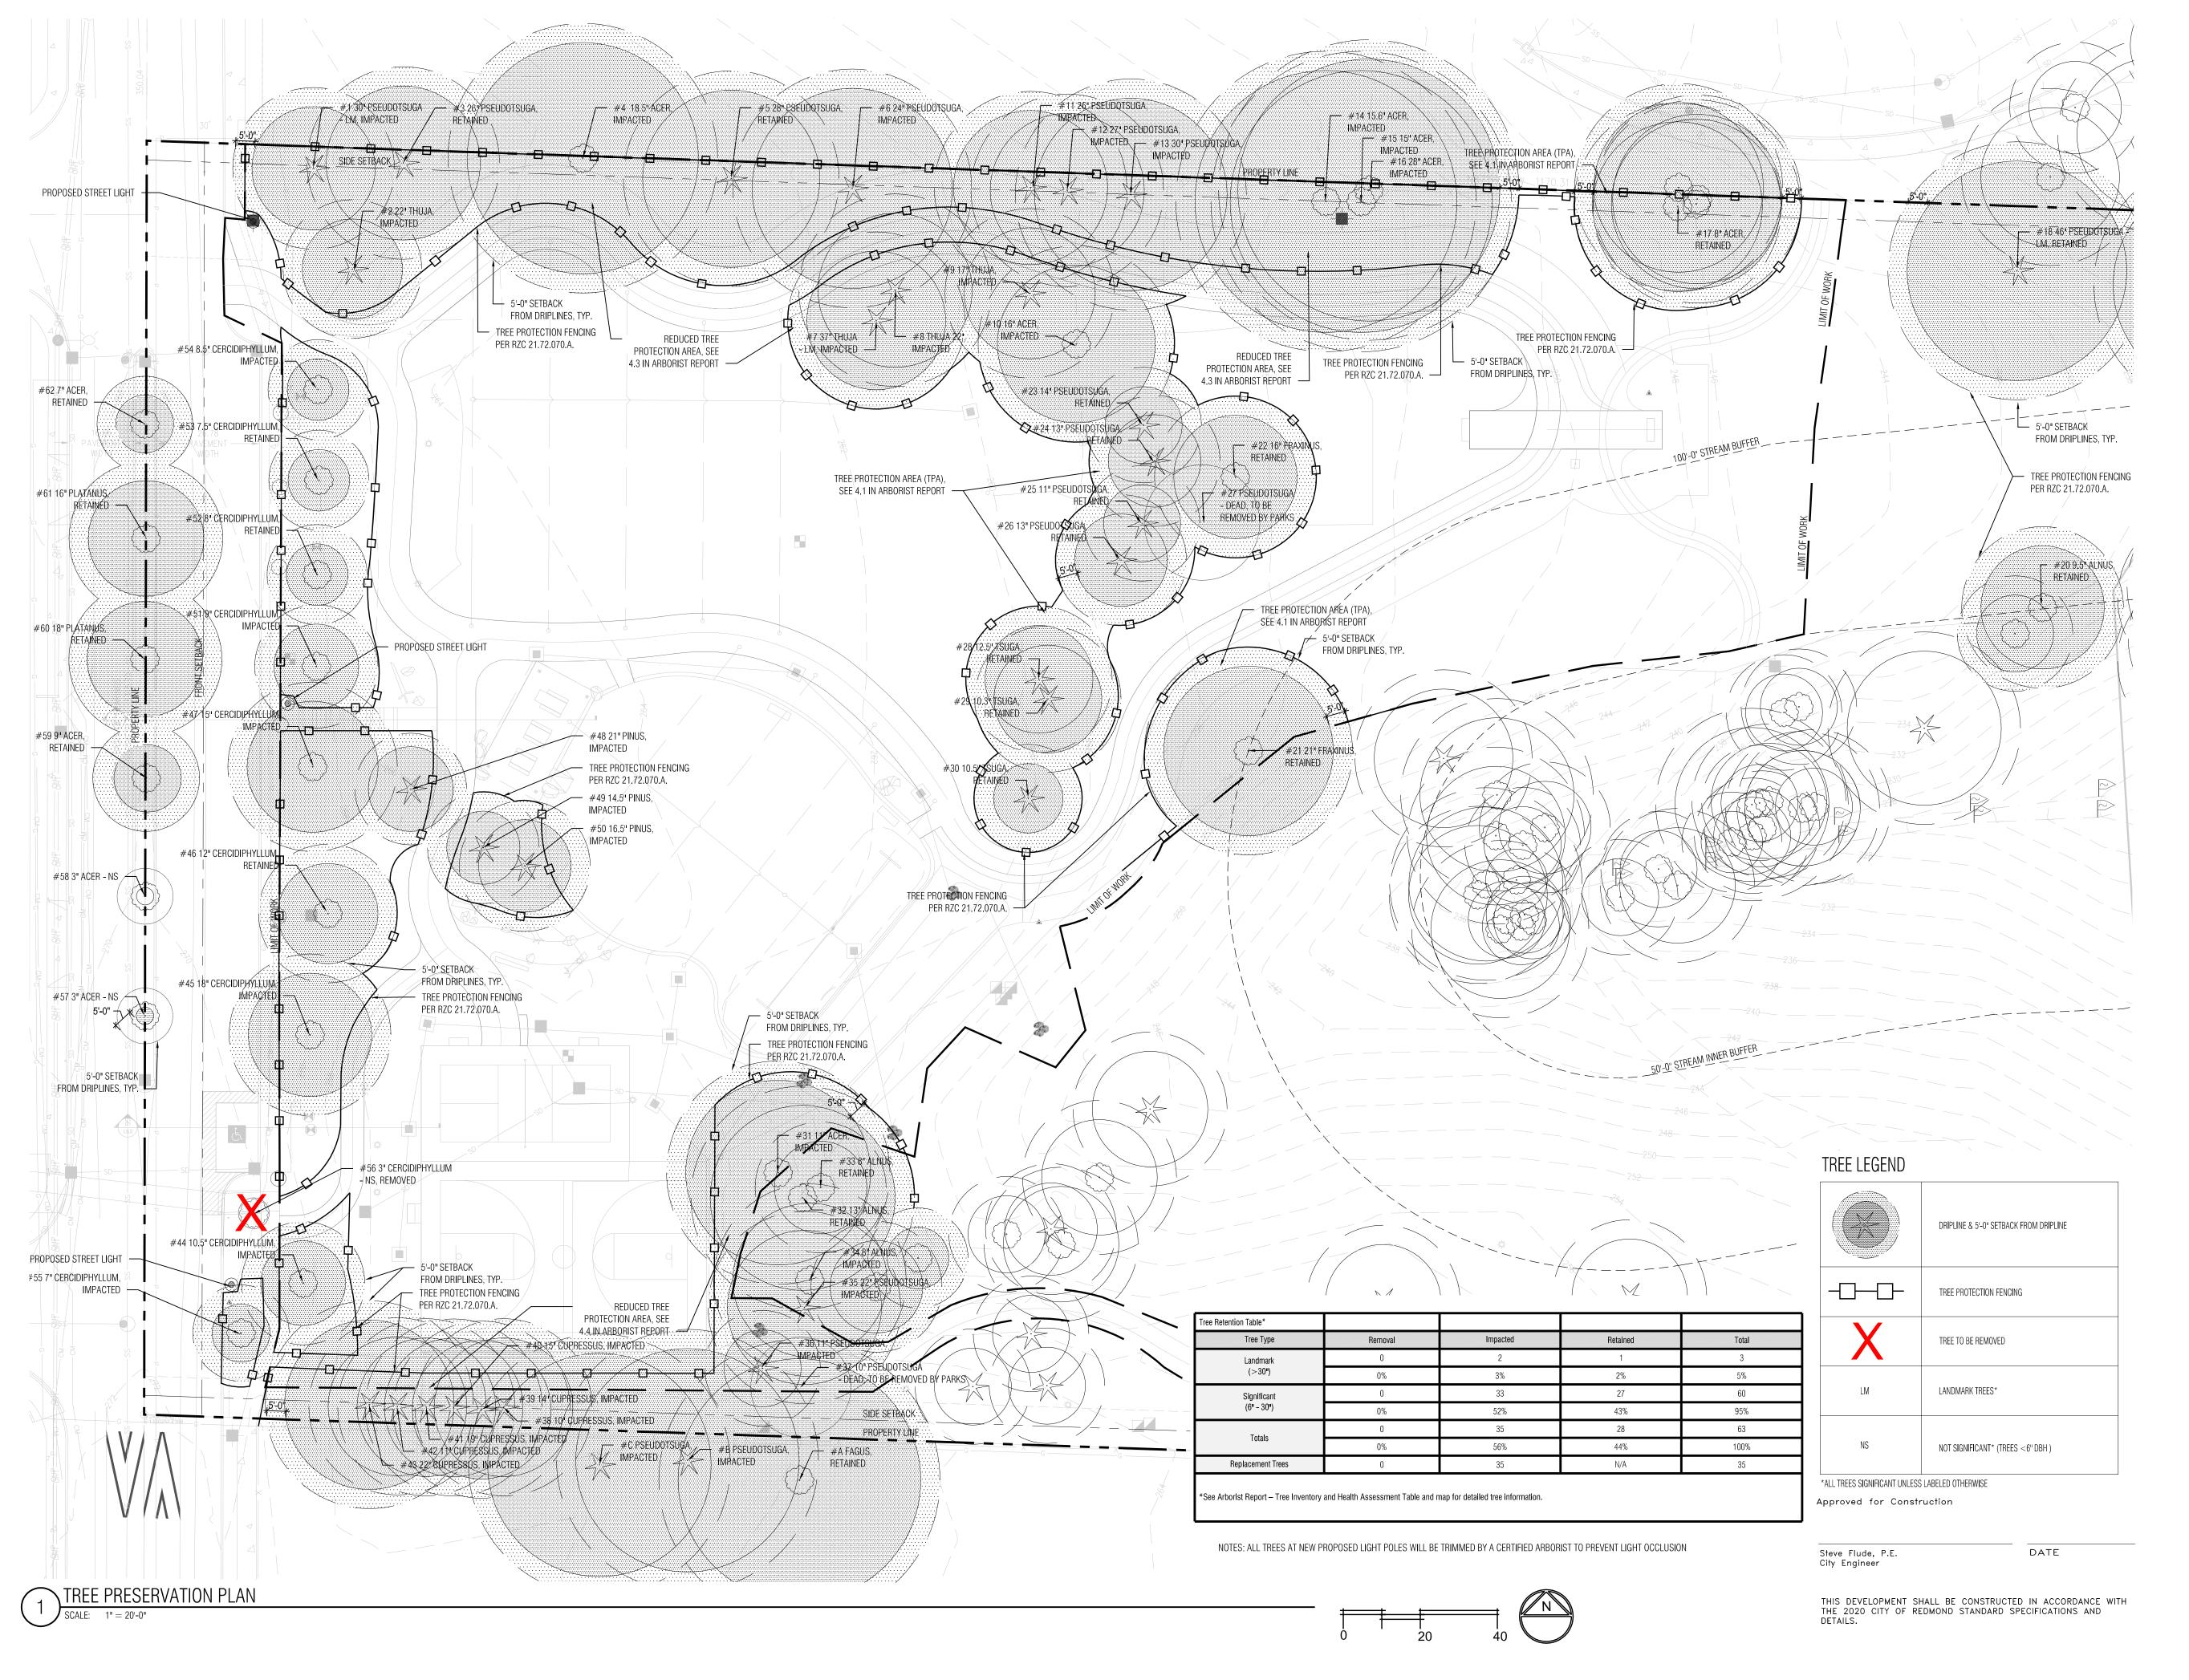

d & Vellun
Ave E. Suite 100 Seattle, WA 98112





REDMOND WESTSIDE PARK RENOVATION 5810 156TH AVENE

S810 156T

S810 156T

REDMOND

OWNER:

CITY OF RE

REVISIONS DATE DESCRIPTION

ISSUANCES		
DATE	DESCRIPTION	
02.26.2020	30% PLANS	

04.20.2020 60% PLANS
04.30.2020 SITE PLAN ENTITLEMENT

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ORIGINAL SHEET SIZE IS 22*x34*

BOARD & VELLUM PROJECT #: 2019176.00

PROJECT #: 500021924

04.30.2020


PLOT DATE:

SHEET:

TREE PRESERVATION PLAN

L1.0

SHEET NO.: 20 OF 35

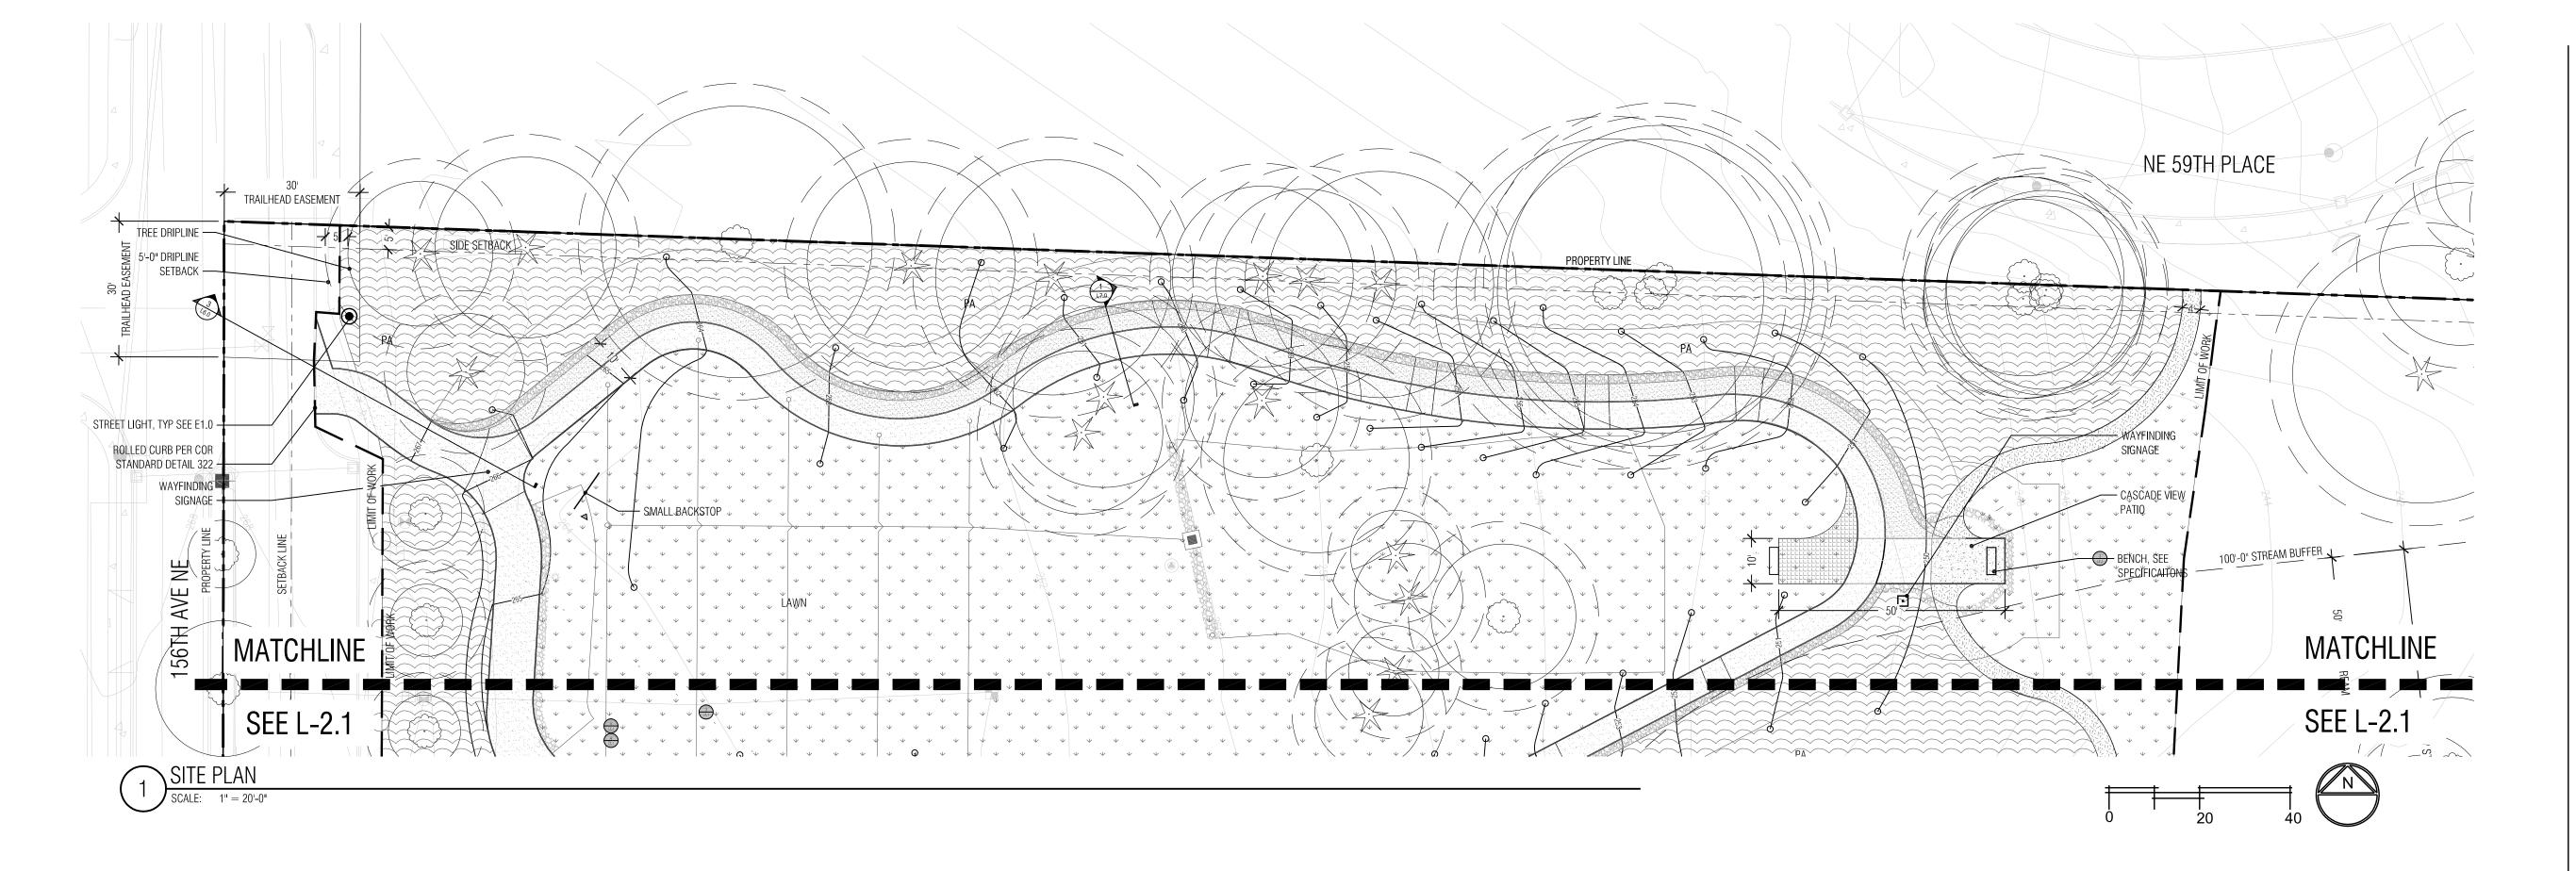

MATERIALS LEGEND

MATERIALO LEGEND						
	MULTIMODAL ASPHALT PATH	1 L7.0				
	MULTIMODAL GRAVELPAVE PATH	1 L7.0				
	SOFT SURFACE TRAIL	7 L7.0				
} < x 7	CONCRETE PAVING	8 L7.0				
	CONCRETE JOINTS/SCORING	8 L7.0				
	GRASSPAVE	5 L7.0				
	CIP CONC CURB AT PLAY AREA	2 L7.1				
	PLAY SURFACE	1 L7.1				

PA	PLANTING AREA	1 14.2
\(\dots \)	LAWN AREAS	1 14.2
	BIORETENTION FACILITY	
	SPORT COURT SURFACING	4 L7.0
	4' HEIGHT FENCE AT PLAY AREA PERIMETER	1 L7.2
0	10' HEIGHT FENCE AT BASKETBALL COURT	3 L7.2
	STREET LIGHT POLE	7 L7.1
	BENCH	3 17.1

•	SIGN	
(*)(0)	TREE WITH DRIPLINE	
***	NATURAL LOG FEATURE	5 L7.1
	NATURAL BOULDER	4 L7.1
83	BIKE RACK	3 L7.1

Approved for Construction

Steve Flude, P.E. City Engineer

THIS DEVELOPMENT SHALL BE CONSTRUCTED IN ACCORDANCE WITH THE 2020 CITY OF REDMOND STANDARD SPECIFICATIONS AND DETAILS.

DATE

ard & Vellum
15th Ave E. Suite 100 Seattle, WA 98112





REDMOND WESTSIDE PARK S810 156TH AVE NE

REVISIONS DATE DESCRIPTION

ISSUANCES

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DATE DESCRIPTION

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04.30.2020 SITE PLAN ENTITLEMENT

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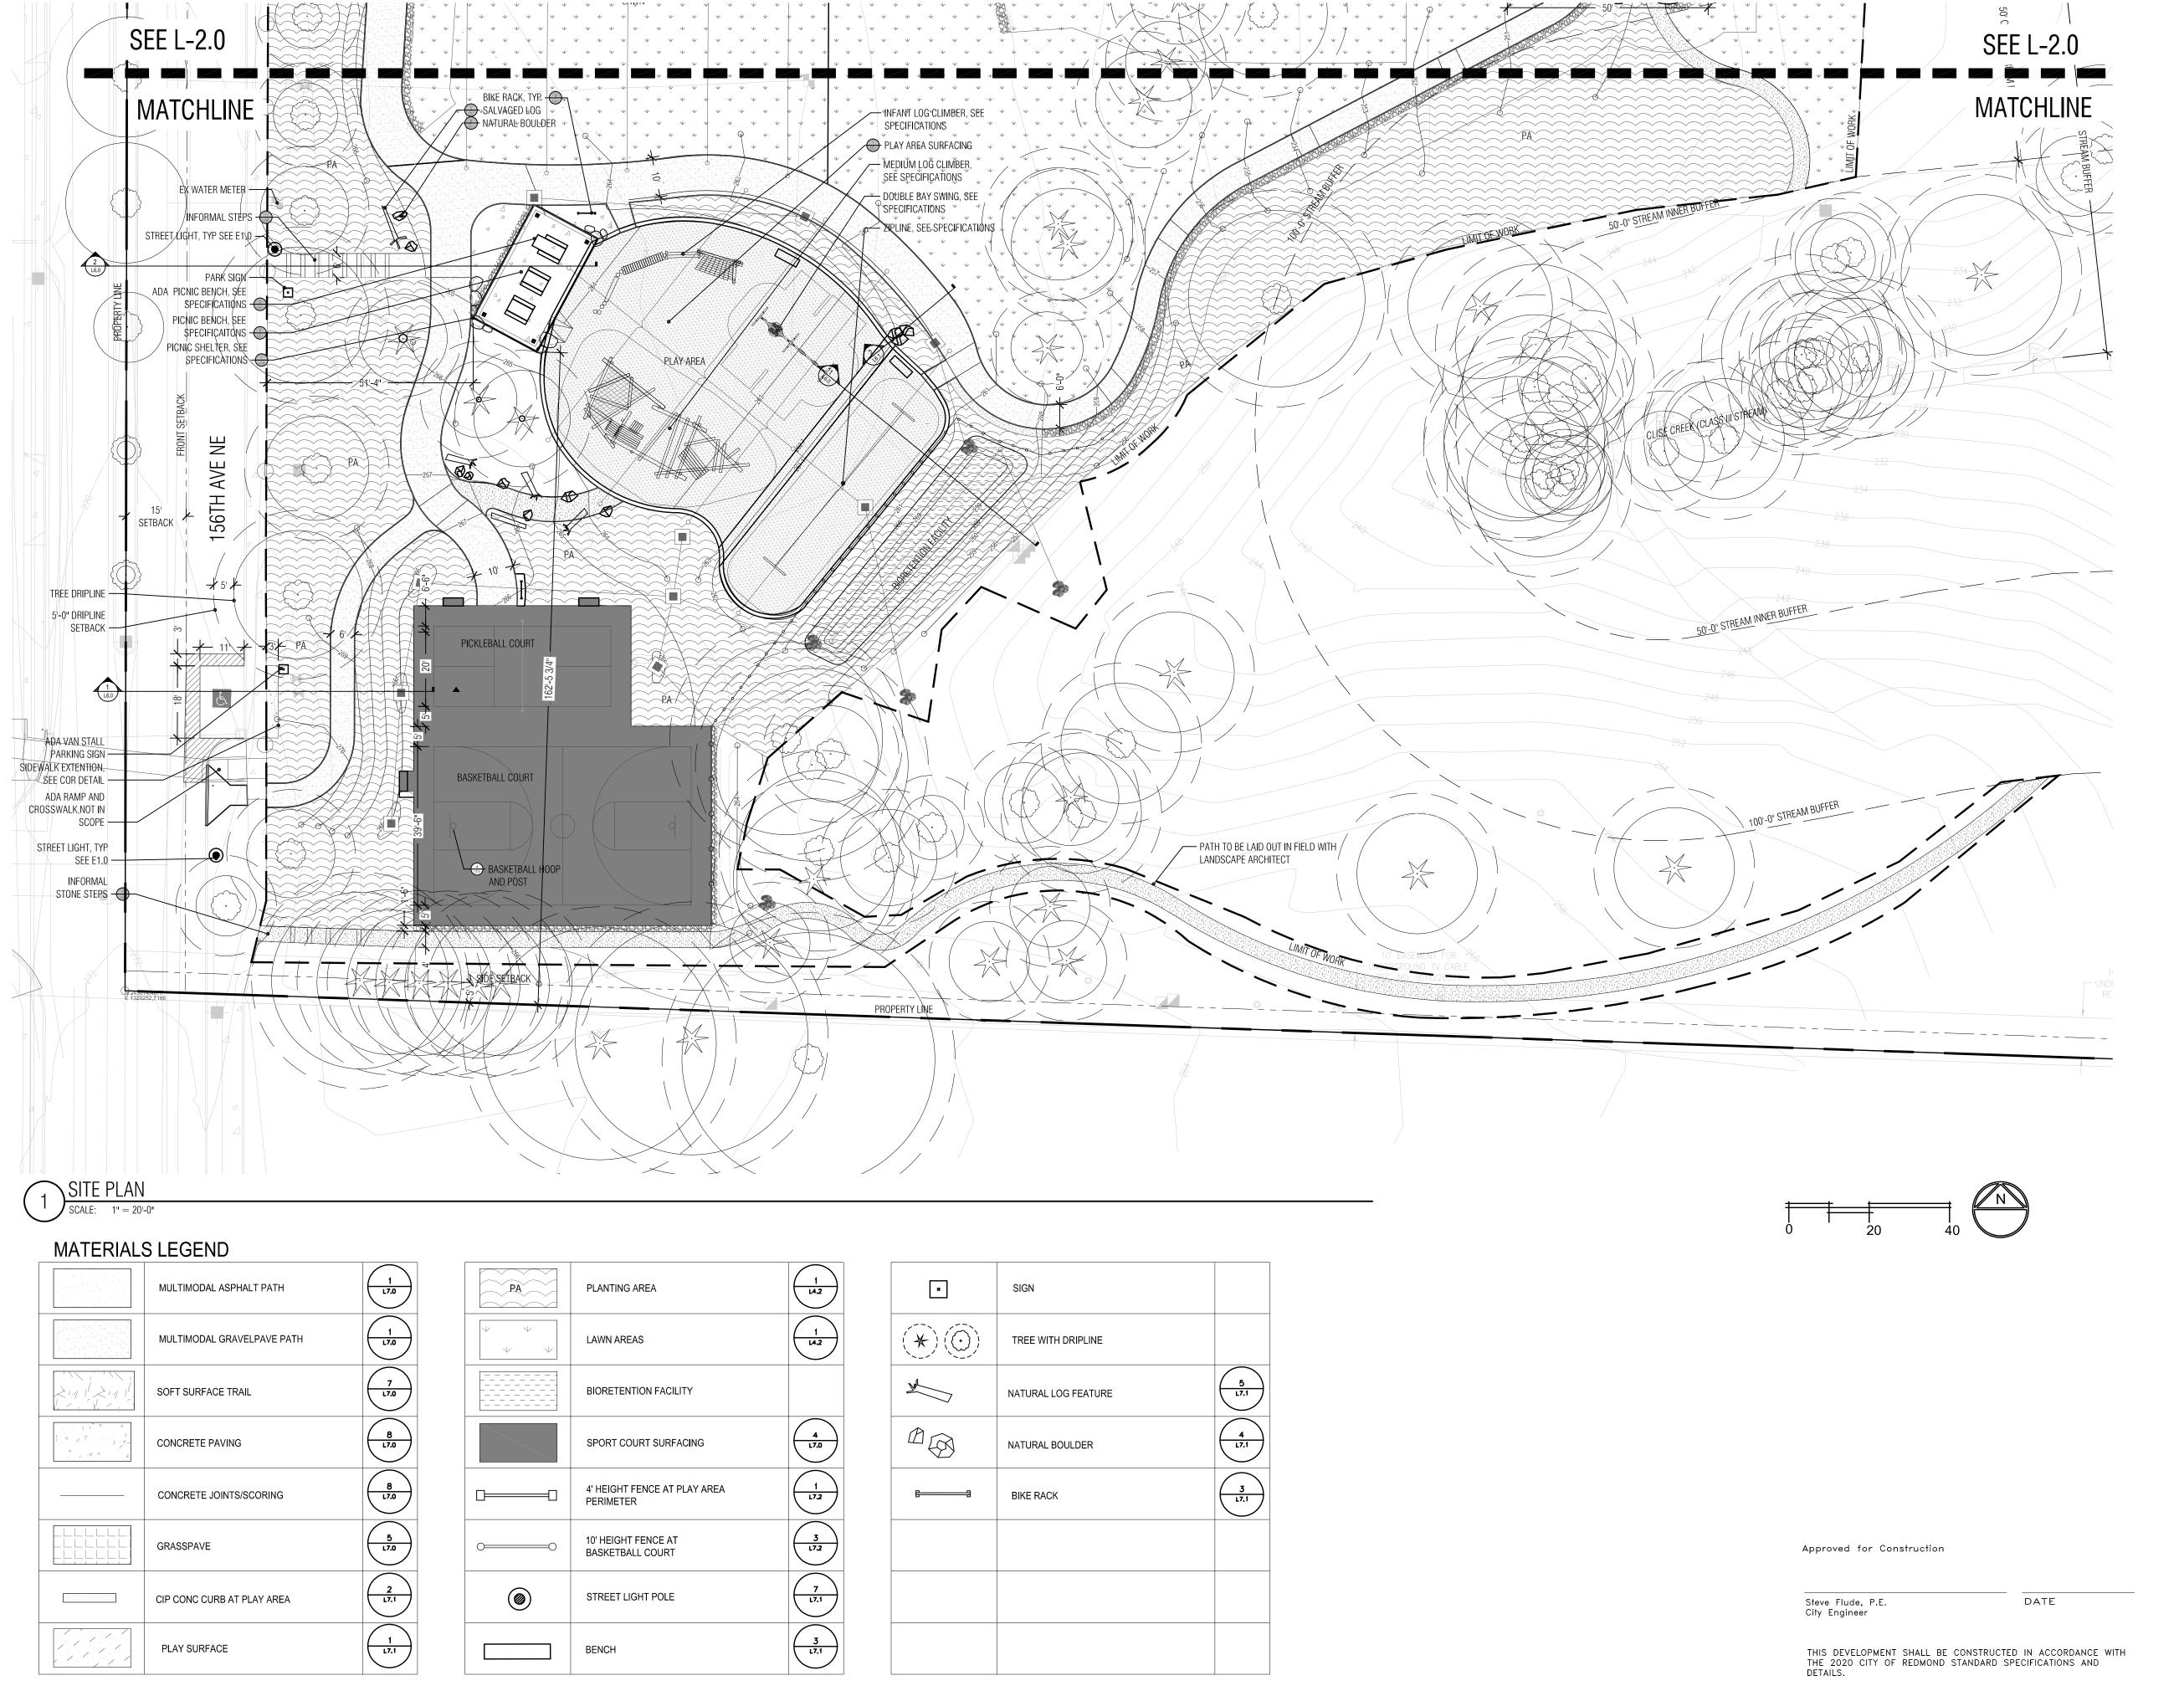
BOARD & VELLUM PROJECT #: 2019176.00
PROJECT #: 500021924

PLOT DATE: 04.30.2020

SITE PLAN NORTH

L2.0

| SHEET NO.: 21 OF 35



ard & Vellum 5 15th Ave E. Suite 100 Seattle, WA 98112





REDMOND WESTSIDE PARK
RENOVATION
5810 156TH AVE NE
REDMOND, WA 98052

REVISIONS DATE DESCRIPTION

ISSUANCES

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 02.26.2020
 30% PLANS

 04.20.2020
 60% PLANS

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BOARD & VELLUM PROJECT #: 2019176.00
PROJECT #: 500021924


PLOT DATE: 04.30.2020

CUEET.

SITE PLAN SOUTH

L2.1

SHEET NO.: 22 OF 35

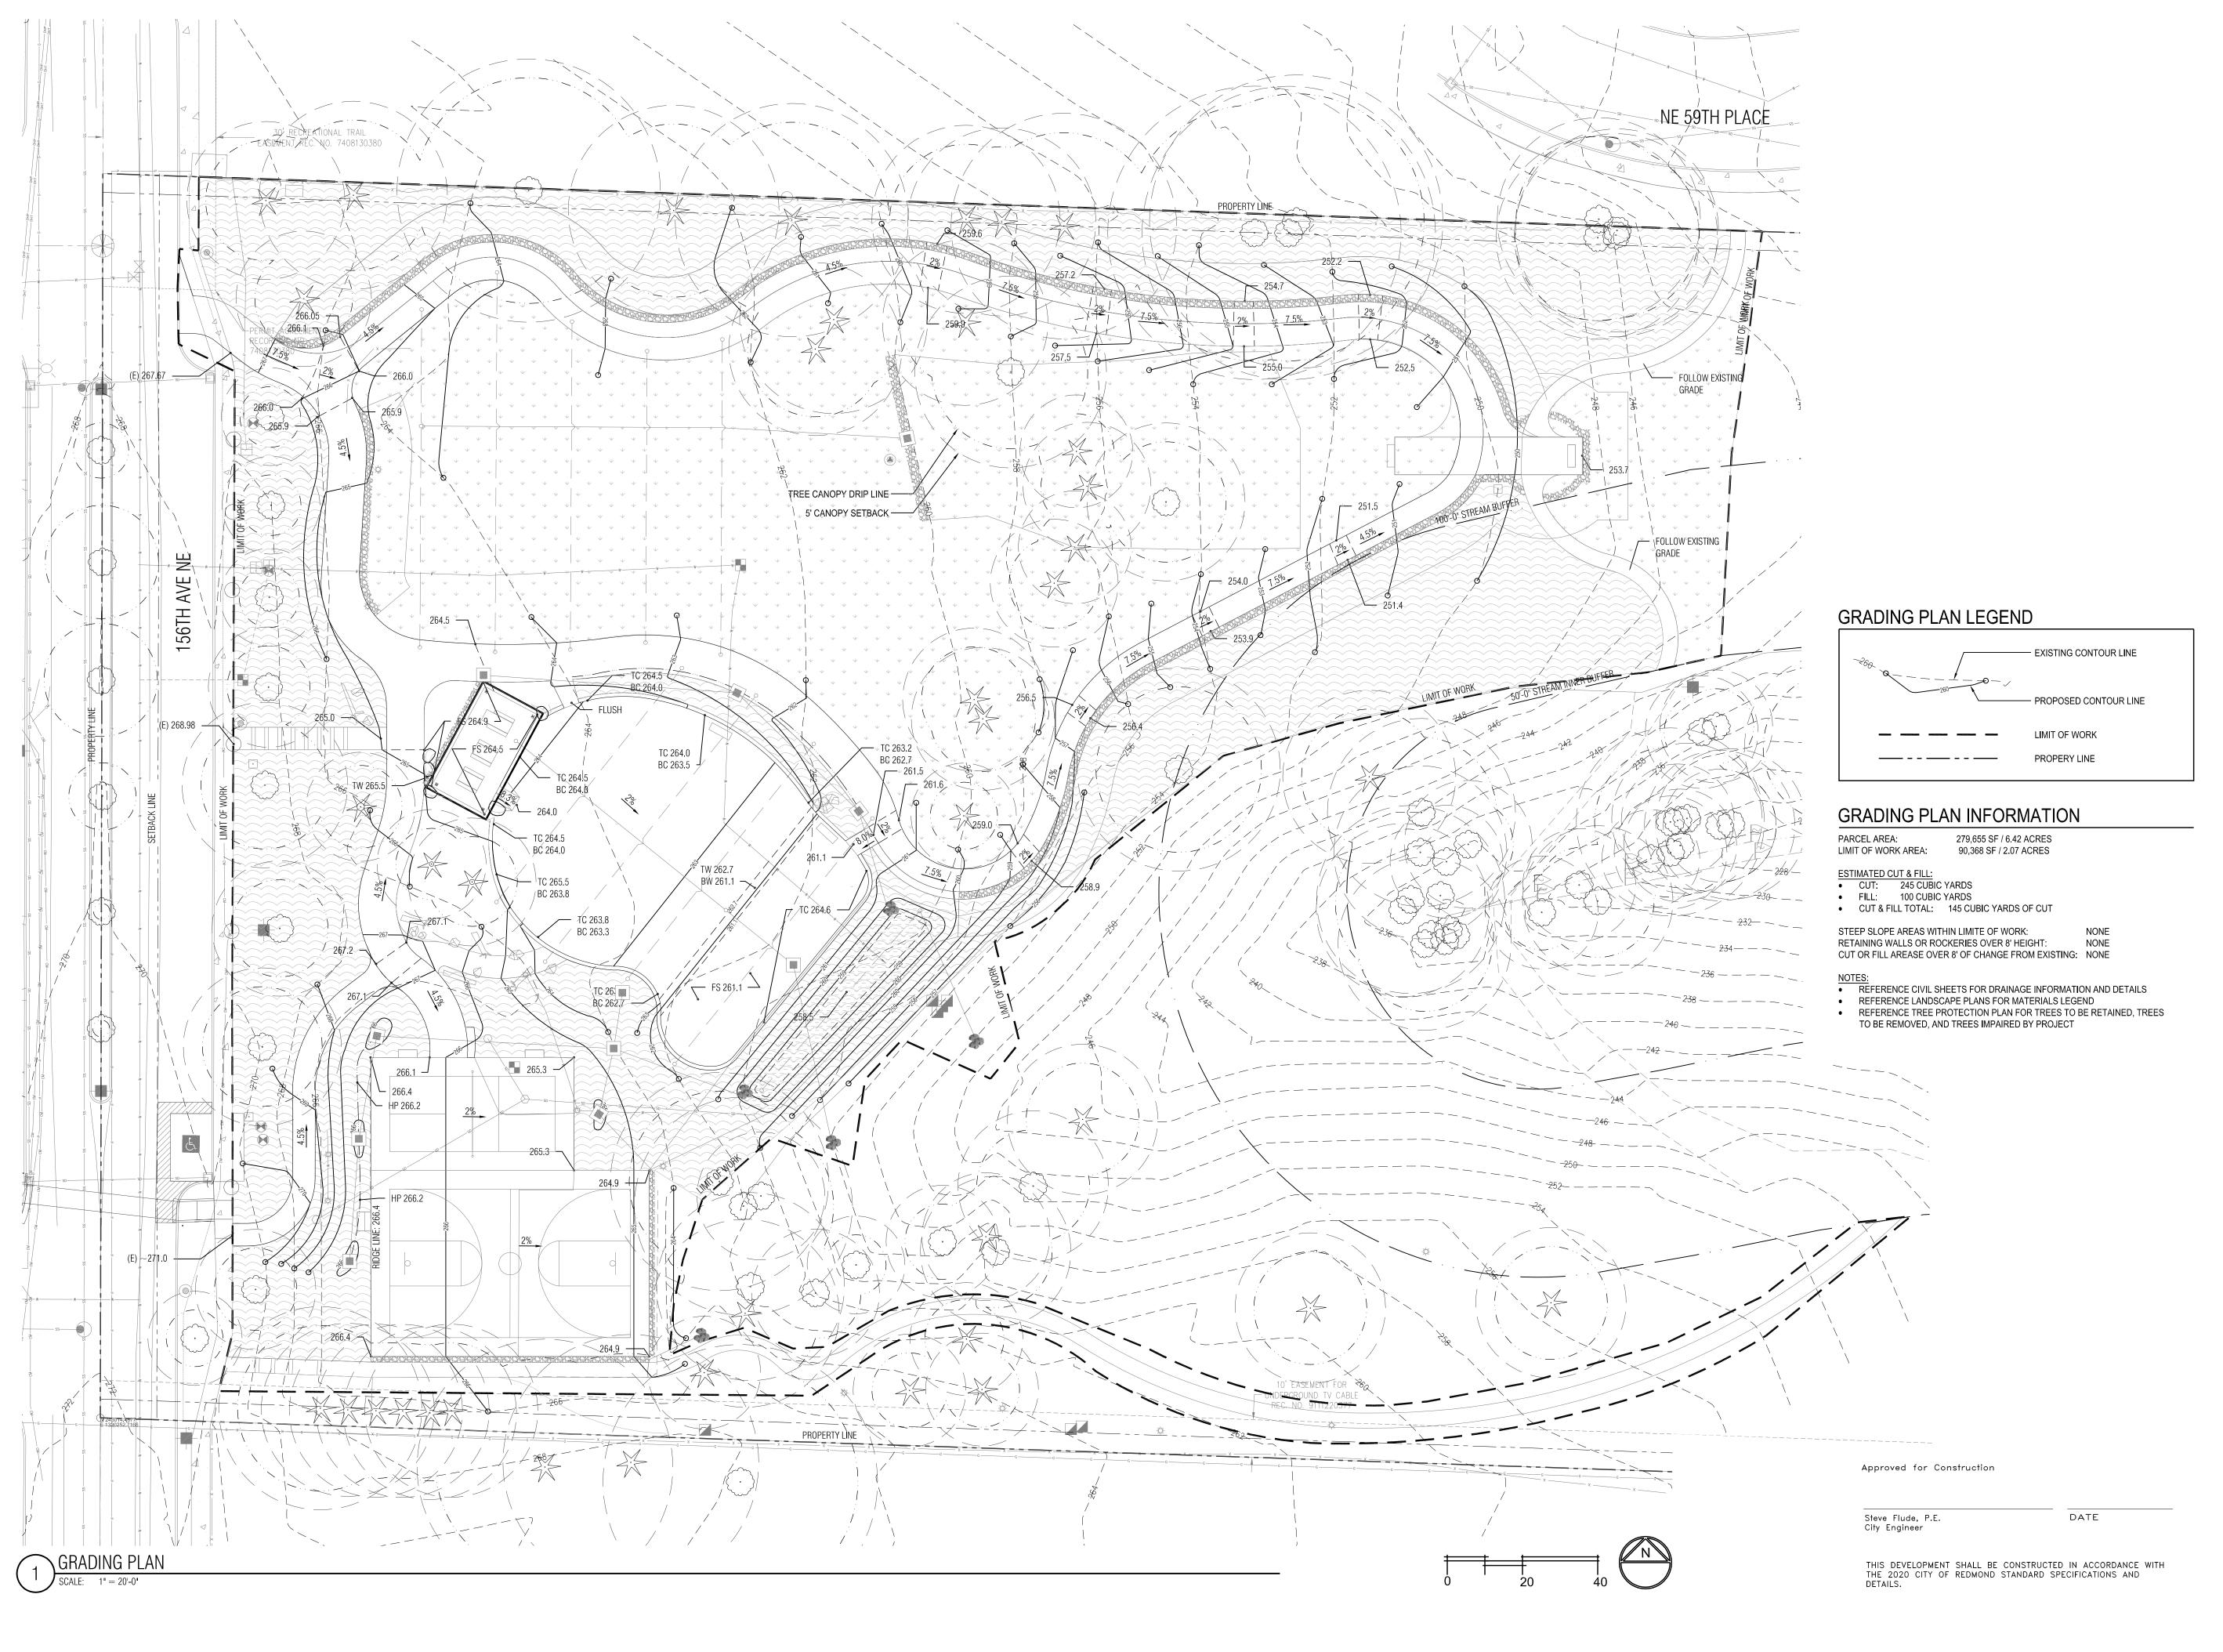







ID WESTSIDE PARK

REDMOND V RENOVATIO 5810 156TH AVE NE REDMOND, WA 98052

REVISIONS DATE DESCRIPTION

ISSUANCES

DATE DESCRIPTION

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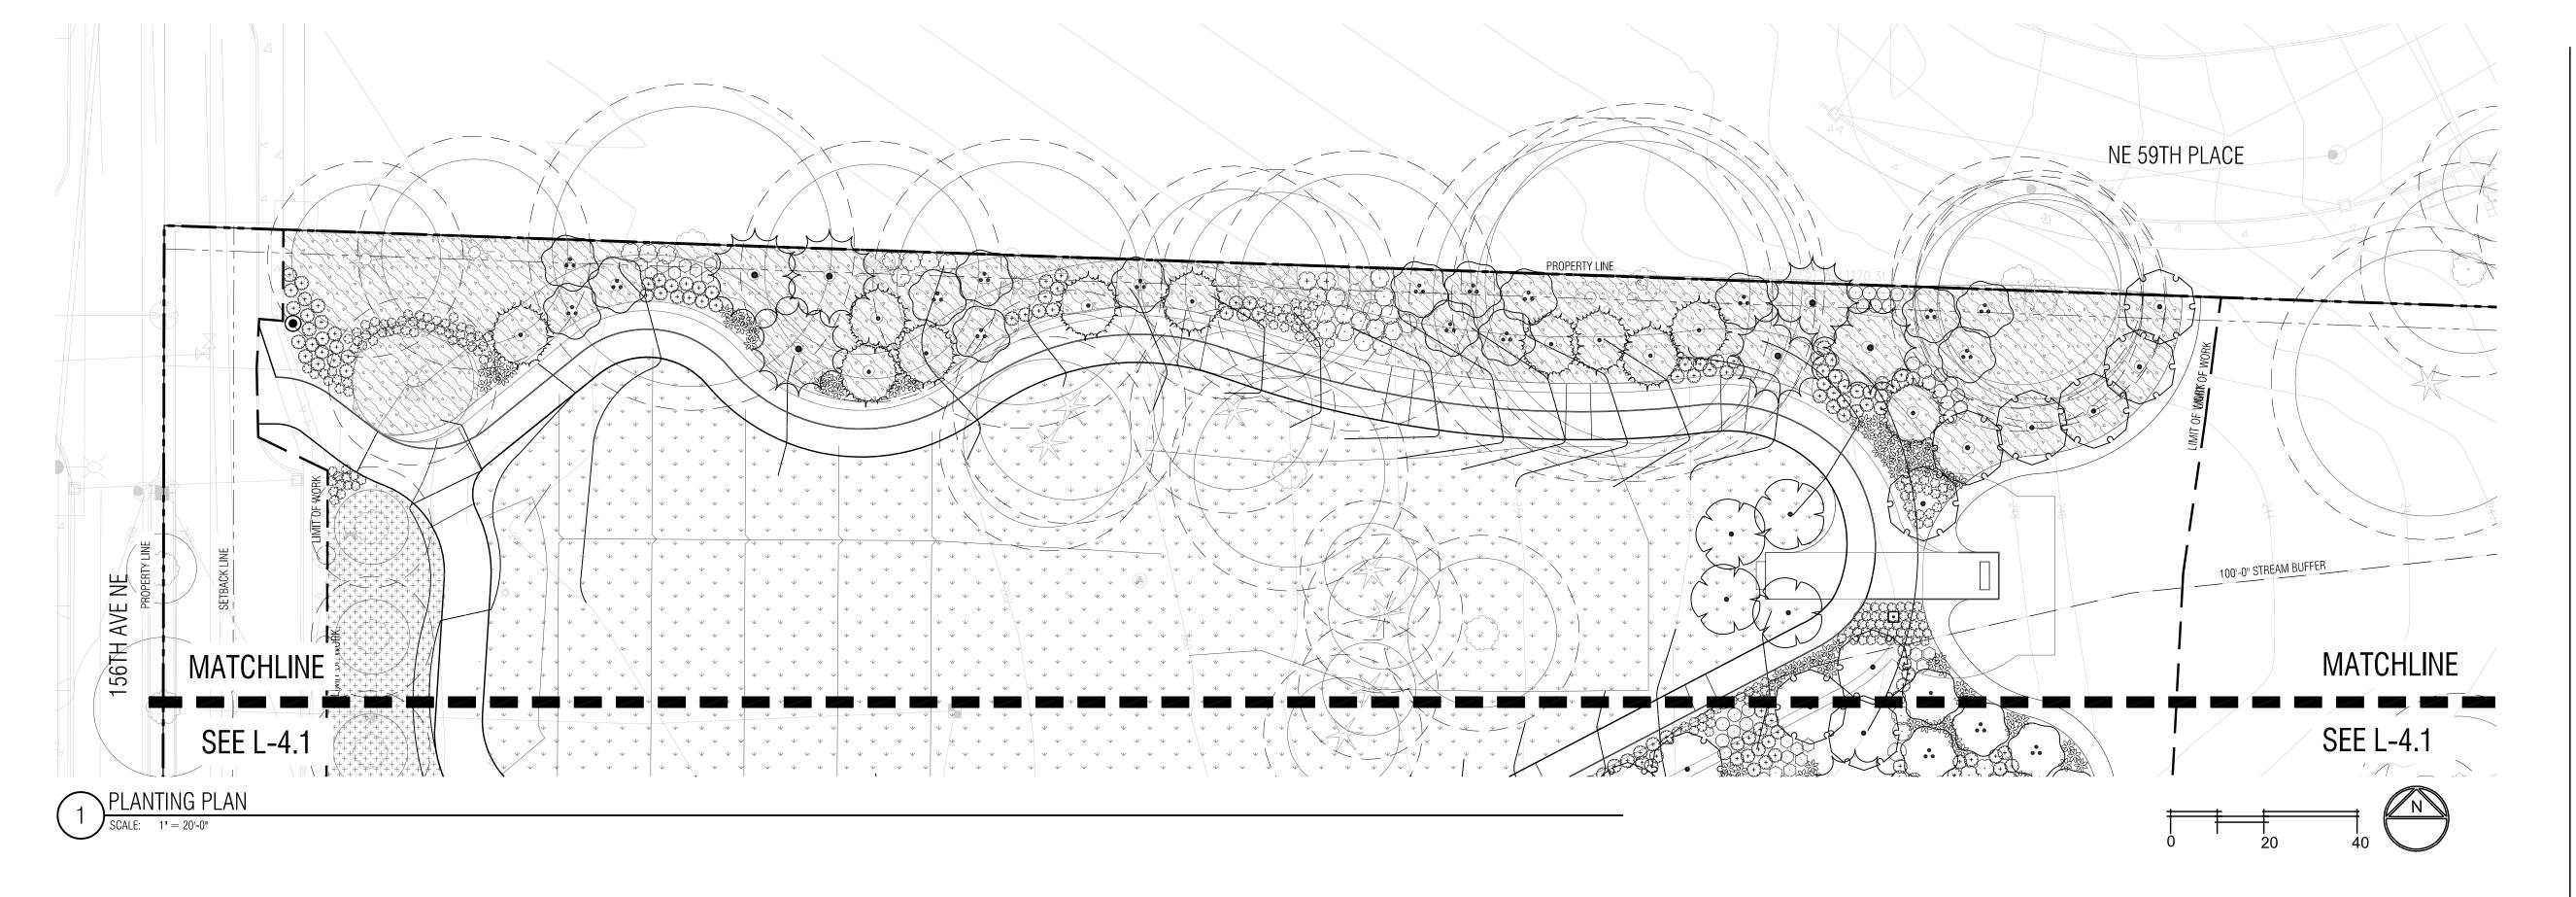
BOARD & VELLUM PROJECT #: 2019176.00
PROJECT #: 500021924

PLOT DATE: 04.30.2020

SHEET:

GRADING PLAN L3.0

SHEET NO.: 23 OF **35**



ΡI	ΔΝΤ	SCHEDULE	
Γ L	./~\! N I	SCHEDULE	

1 17 (141 00)	ILDOLL								
TREES	QTY	BOTANICAL / COMMON NAME	CONT	CAL	SIZE	NAT/ADAPT	DROUGHT TOL	TYPE	REMARKS
	26	Acer circinatum / Vine Maple	B&B, MULTISTEM		4`-5` HT	YES	YES	DECIDUOUS	
	17	Cercis occidentalis / Western Redbud Multi-trunk	B&B	2.5"Cal		YES	YES	DECIDUOUS	(2) REPLACEMENT TREES
when the second	7	Cornus kousa / Kousa Dogwood	B&B	2.5"Cal		YES	YES	DECIDUOUS	REPLACEMENT TREE
marray A	16	Pinus contorta / Shore Pine	B & B		6`-8` HT	YES	YES	EVERGREEN	REPLACEMENT TREE
•	14	Thuja plicata / Western Red Cedar	B&B		6`-8` HT	YES	YES	EVERGREEN	REPLACEMENT TREE
SHRUBS	QTY	BOTANICAL / COMMON NAME	SIZE	NAT/ADAPT	DROUGHT TOL				REMARKS
\bigcirc	284	Gaultheria shallon / Salal	1 gal	YES	YES				
+	18	Holodiscus discolor / Ocean-spray	1 gal	YES	YES				
Exercise State of the state of	237	Mahonia aquifolium / Oregon Grape	1 gal	YES	YES				
\bigcirc	21	Oemleria cerasiformis / Indian Plum	1 gal	YES	YES				
	209	Polystichum munitum / Western Sword Fern	1 gal	YES	YES				
\bigcirc	59	Ribes sanguineum / Red Flowering Currant	5 gal	YES	YES				
\bigcirc	68	Symphoricarpos albus / Common White Snowberry	1 gal	YES	YES				
\odot	117	Vaccinium ovatum / Evergreen Huckleberry	1 gal	YES	YES				
BIORETENTION	QTY	BOTANICAL / COMMON NAME	SIZE	NAT/ADAPT	DROUGHT TOL				REMARKS
€3	25	Aquilegia formosa / Western Columbine	1 gal	YES	YES				
ZWZ	102	Carex stipata / Sawbeak Sedge	1 gal	YES	YES				
6 . 3 . 3 . 3 . 3 . 3 . 3 . 3 . 3 . 3 .	17	Cornus sericea / Red Twig Dogwood	1 gal	YES	YES				
	59	Deschampsia cespitosa / Tufted Hair Grass	1 gal	YES	YES				
	55	Eleocharis palustris / Great Spike Rush	1 gal	YES	YES				

PLANT SCEDULE CONT.

INI SOLDOLL OC	7111.				
GROUND COVERS	QTY	BOTANICAL / COMMON NAME	CONT	NAT/ADAPT	DROUGHT TOL
	2,265 sf	BUTTERFLY GARDEN	seed	YES	YES
1 1 1 1 1 1 1 1 1 1 1 1 1 1 1 1 1 1 1	8,733 sf	MULCH COVER			
+++++++ ++++++ +++++++ +++++++ +++++++ ++++	3,686 sf	TURF - EXISTING / EXISTING TURF			
\(\psi\) \(\	27,549 sf	Turf Hydroseed 100% Perennial Rye Seed / Blue Tag	seed		YES

ECOLOGICAL SCORE REQUIREMENTS		
TECHNIQUE	How Technique achieved	POINTS AWARDED - OVERLAKE VILLAGE
1. 25% of the plants installed are Northwest adaptive and 25% of the plants installed are native.*	Total plants installed: 1,343 Total plants NW adaptive: 7 (0.5%) Total plants native: 1,336 (99%)	5 POINTS
2. 40% of existing significant trees, including landmark trees, are retained.	Retained (no impacts): 44%	3 POINTS
3. Minimum of 25% of proposed trees are evergreens.	Proposed Trees: 80, Proposed Evergreen Trees: 30 (38%)	3 POINTS
6. 10% increase over the minimum number of required replacement trees, street trees, or parking lot trees.*	Minimum number of required replacement trees: 35 Proposed replacement Trees: 39 (10%)	3 POINTS
10. Minimum of 25% of landscaped areas are designed with landscaping that does not require irrigation after a three-year period.	Total Landscaped Area: +/- 30,000 SF Temporary irrigation area: 20,000 SF (67%)	3 POINTS
11. Minimum of 50% of landscaped areas where native soils are preserved on-site.	Landscape Areas native soil preserved: 30,000 SF	4 POINTS
	TOTAL	21 POINTS

Approved for Construction

Steve Flude, P.E. City Engineer

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DATE





REDMOND WESTSIDE PARK RENOVATION 5810 156TH AVE NE REDMOND, WA 98052

REVISIONS DATE DESCRIPTION

ISSUANCES

DATE DESCRIPTION

02.26.2020 30% PLANS 04.20.2020 60% PLANS


04.30.2020 SITE PLAN ENTITLEMENT

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BOARD & VELLUM PROJECT #: 2019176.00 500021924 PROJECT #: PLOT DATE: 04.30.2020

SHEET: PLANTING PLAN NORTH & SCHEDULE

SHEET NO.: 24 OF 35

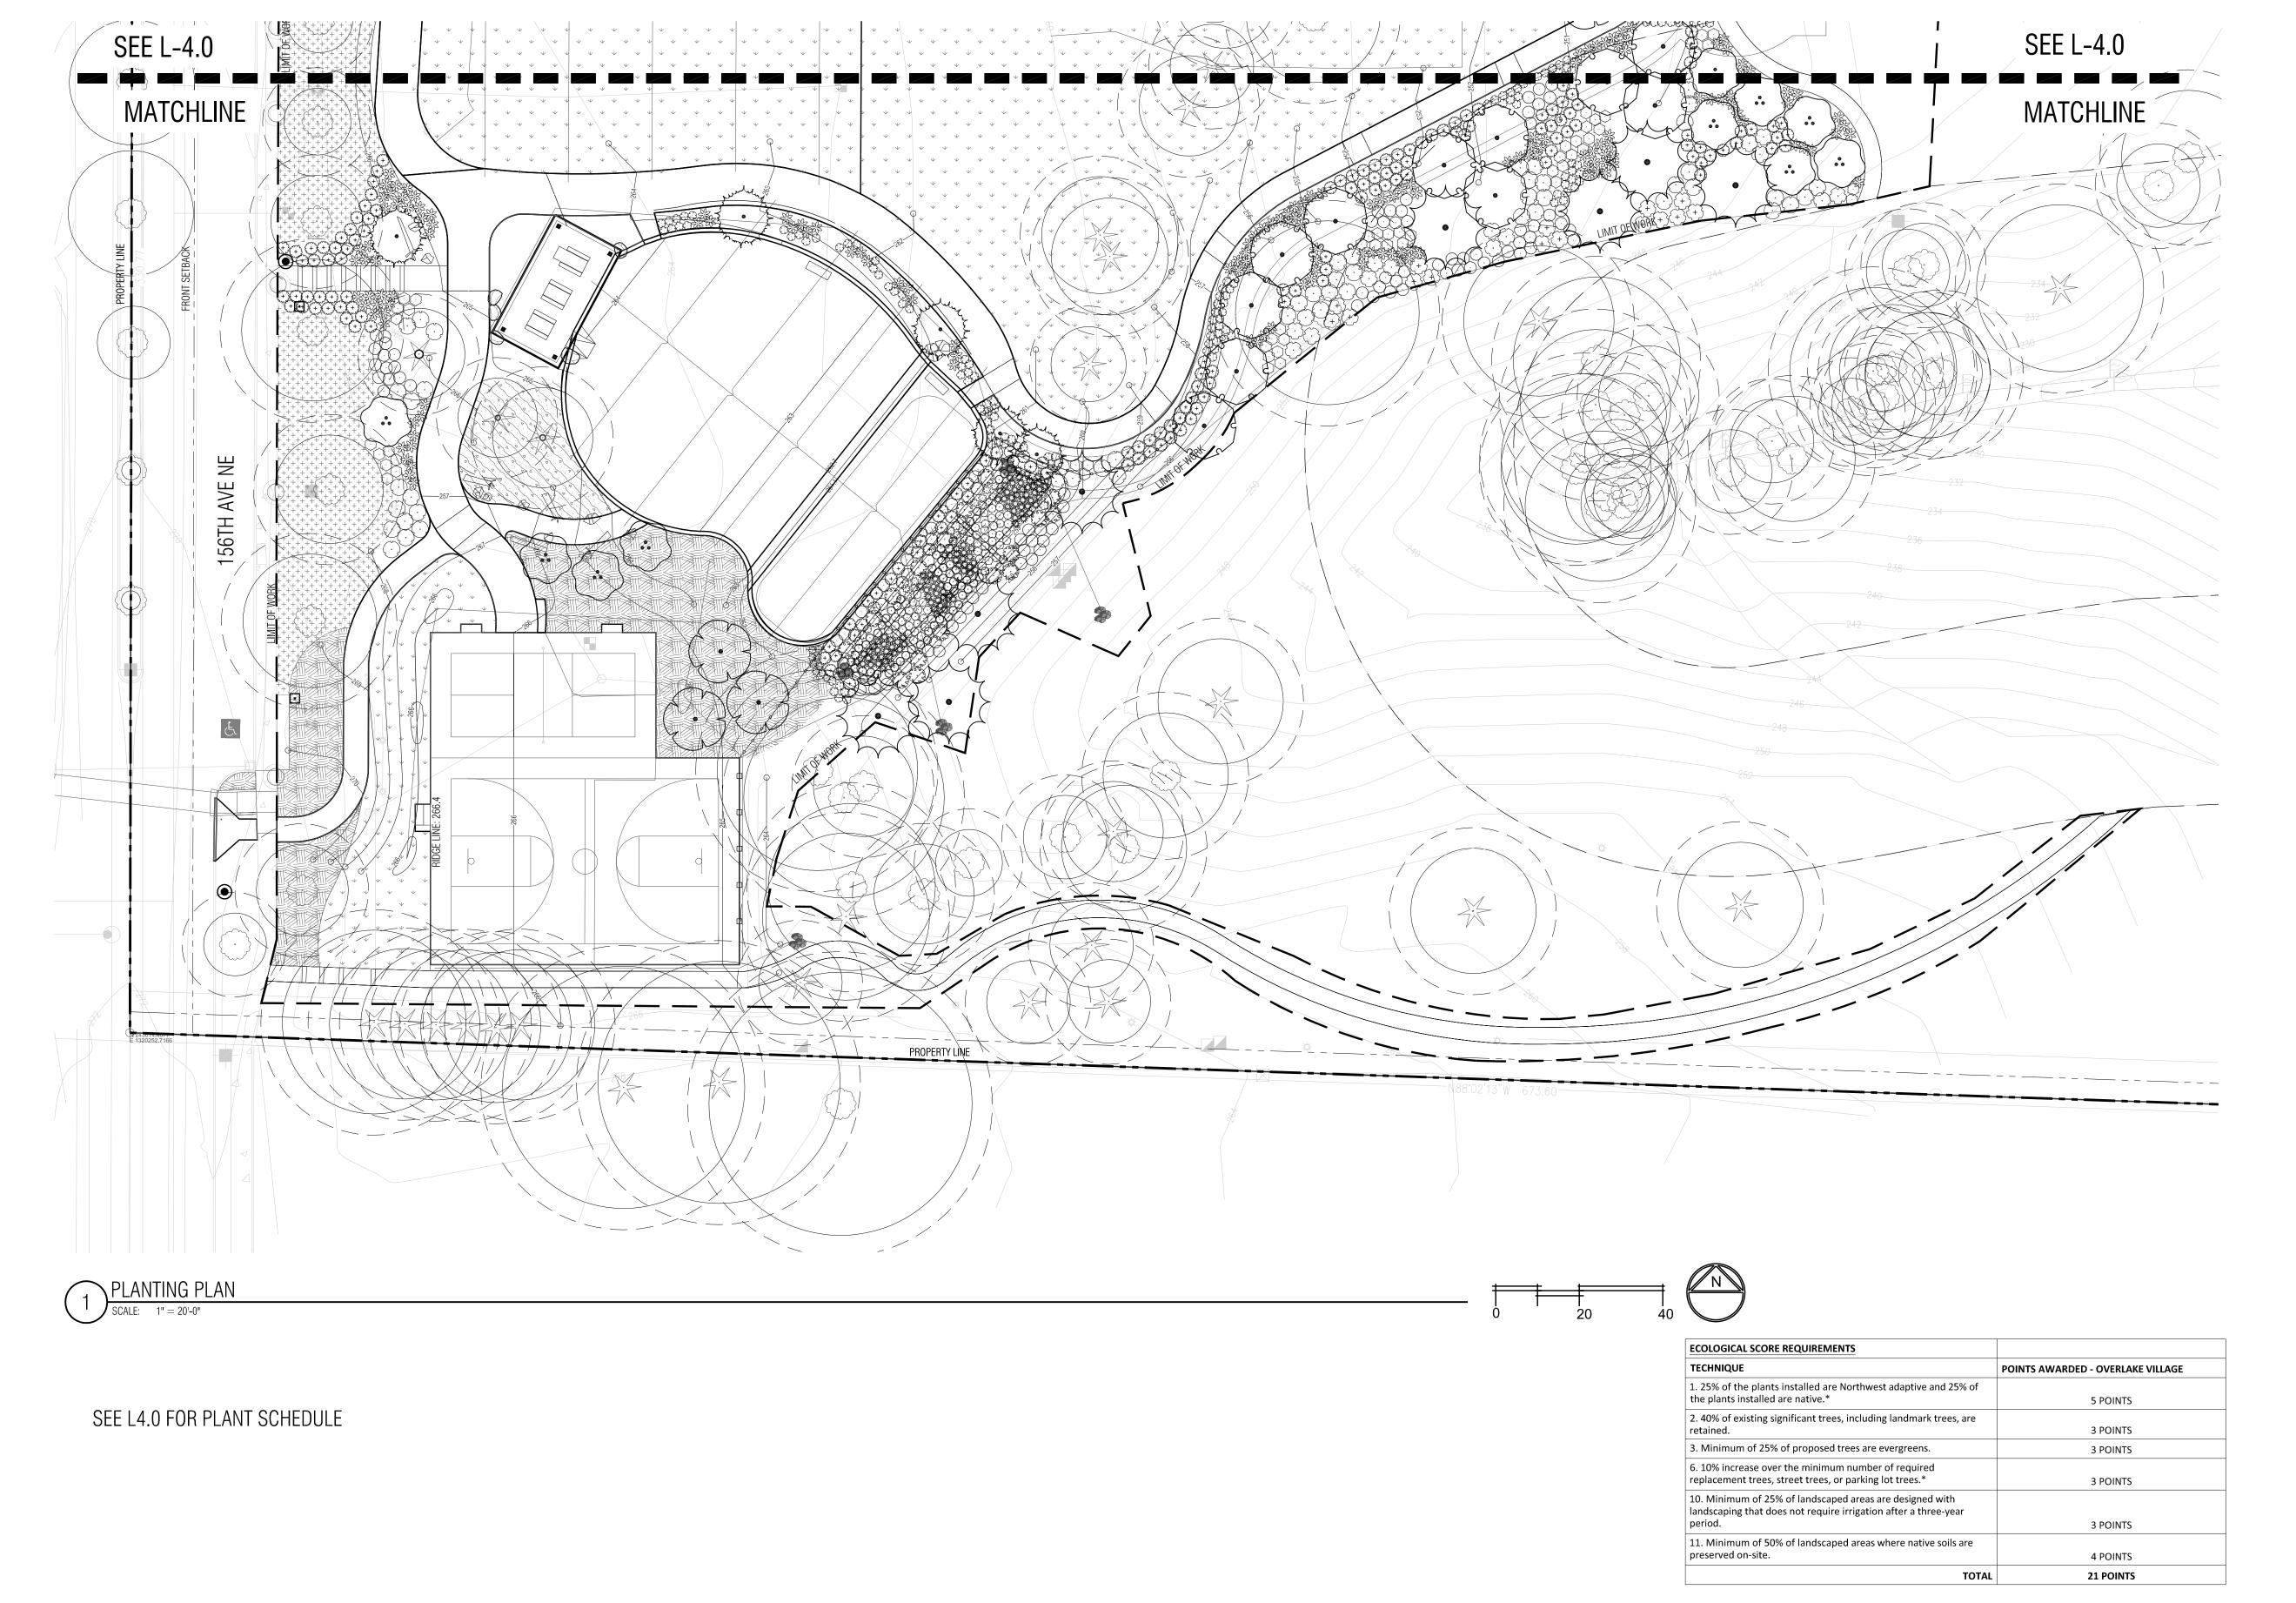

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REDMOND WESTSIDE PARK
RENOVATION
5810 156TH AVE NE
REDMOND, WA 98052

REVISIONS DATE DESCRIPTION

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PROJECT #: 500021924

PLOT DATE: 04.30.2020

SHEET:

Approved for Construction

DATE


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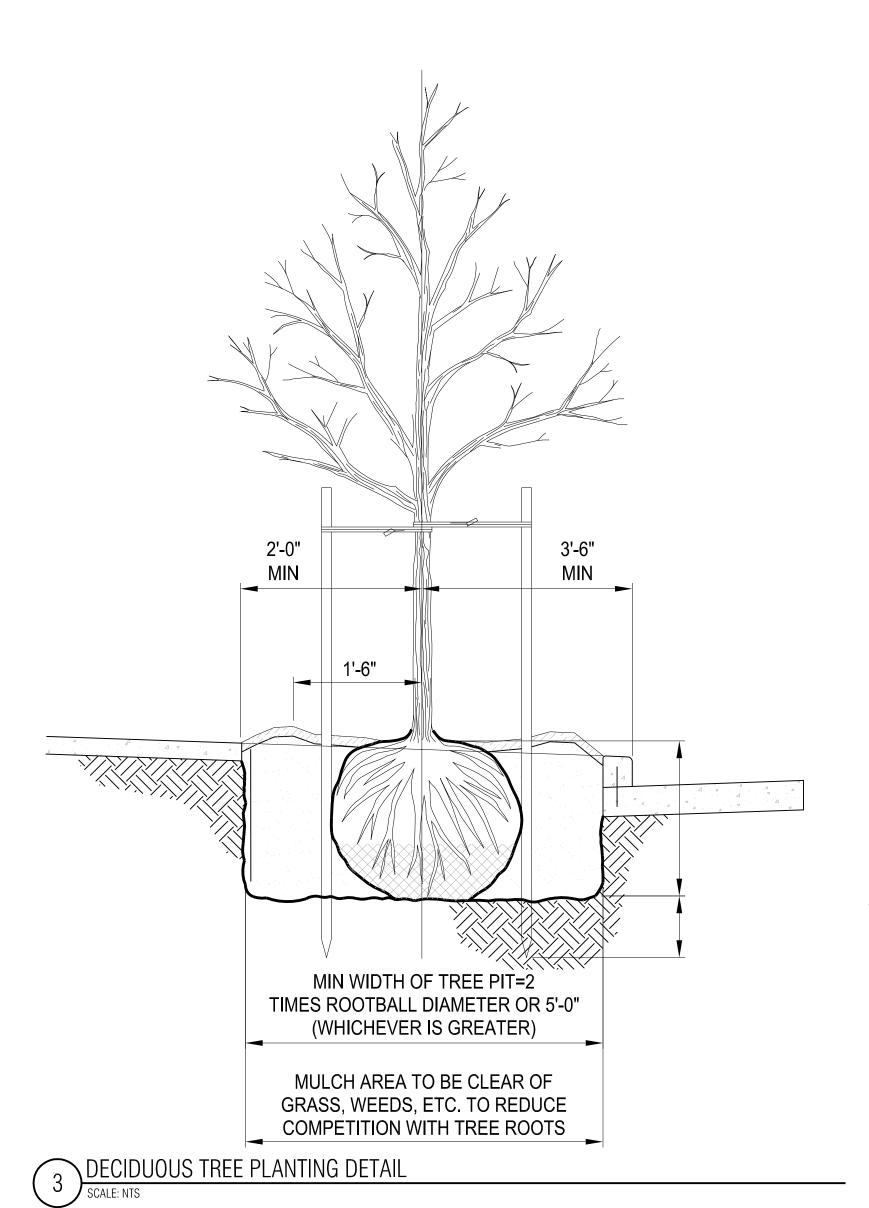
Steve Flude, P.E. City Engineer


PLANTING PLAN SOUTH


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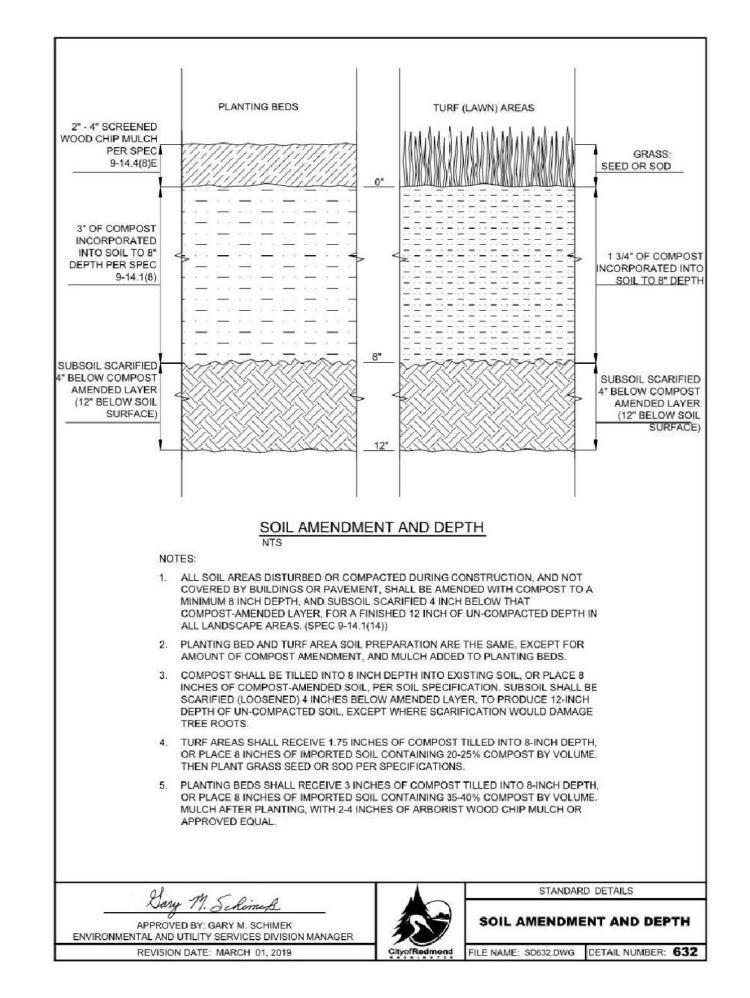
SHEET NO.: 25 OF 35





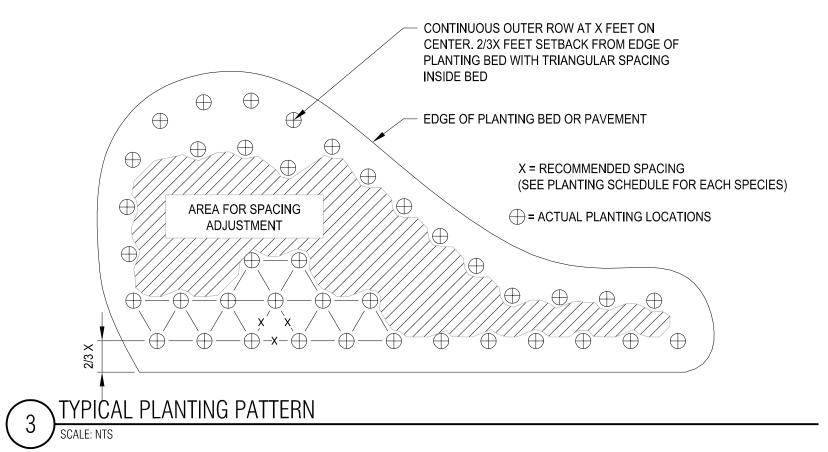

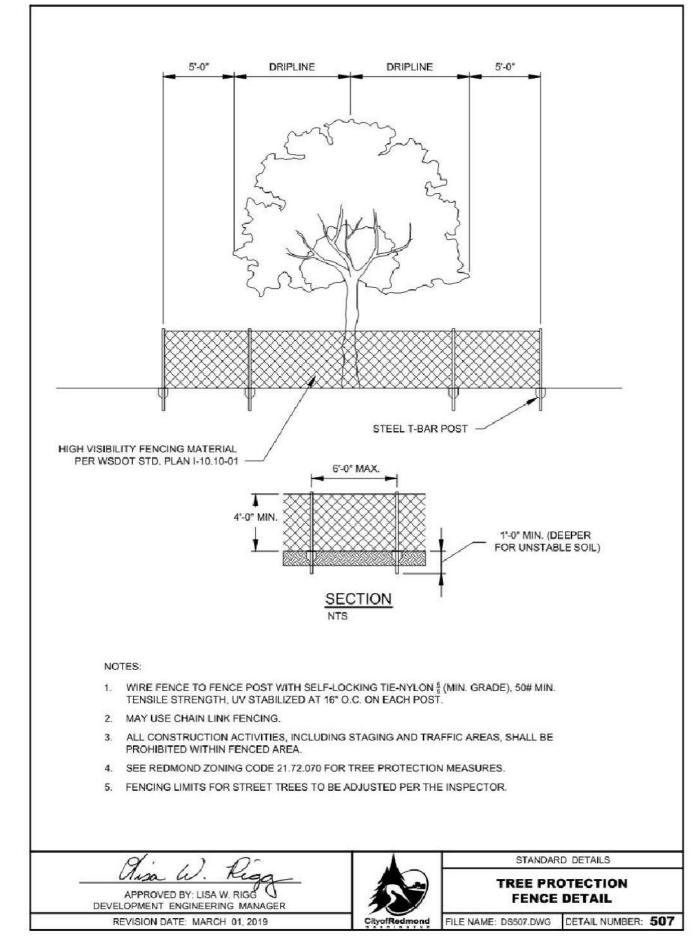

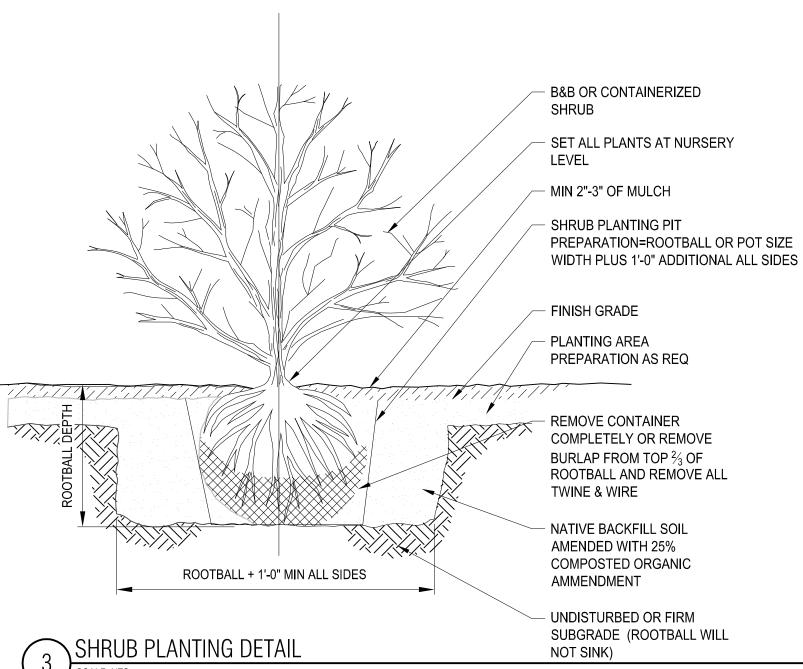

Approved for Construction

Steve Flude, P.E. City Engineer

DATE

THIS DEVELOPMENT SHALL BE CONSTRUCTED IN ACCORDANCE WITH THE 2020 CITY OF REDMOND STANDARD SPECIFICATIONS AND DETAILS.

PLANTING DETAILS

SHEET NO.: 26 OF 35

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PARK

WESTSIDE ION

REDMOND RENOVATION

REVISIONS DATE

ISSUANCES

PROJECT #:

PLOT DATE:

SHEET:

DATE DESCRIPTION

02.26.2020 30% PLANS

04.20.2020 60% PLANS

04.30.2020 SITE PLAN ENTITLEMENT


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BOARD & VELLUM PROJECT #: 2019176.00

500021924

04.30.2020

DESCRIPTION

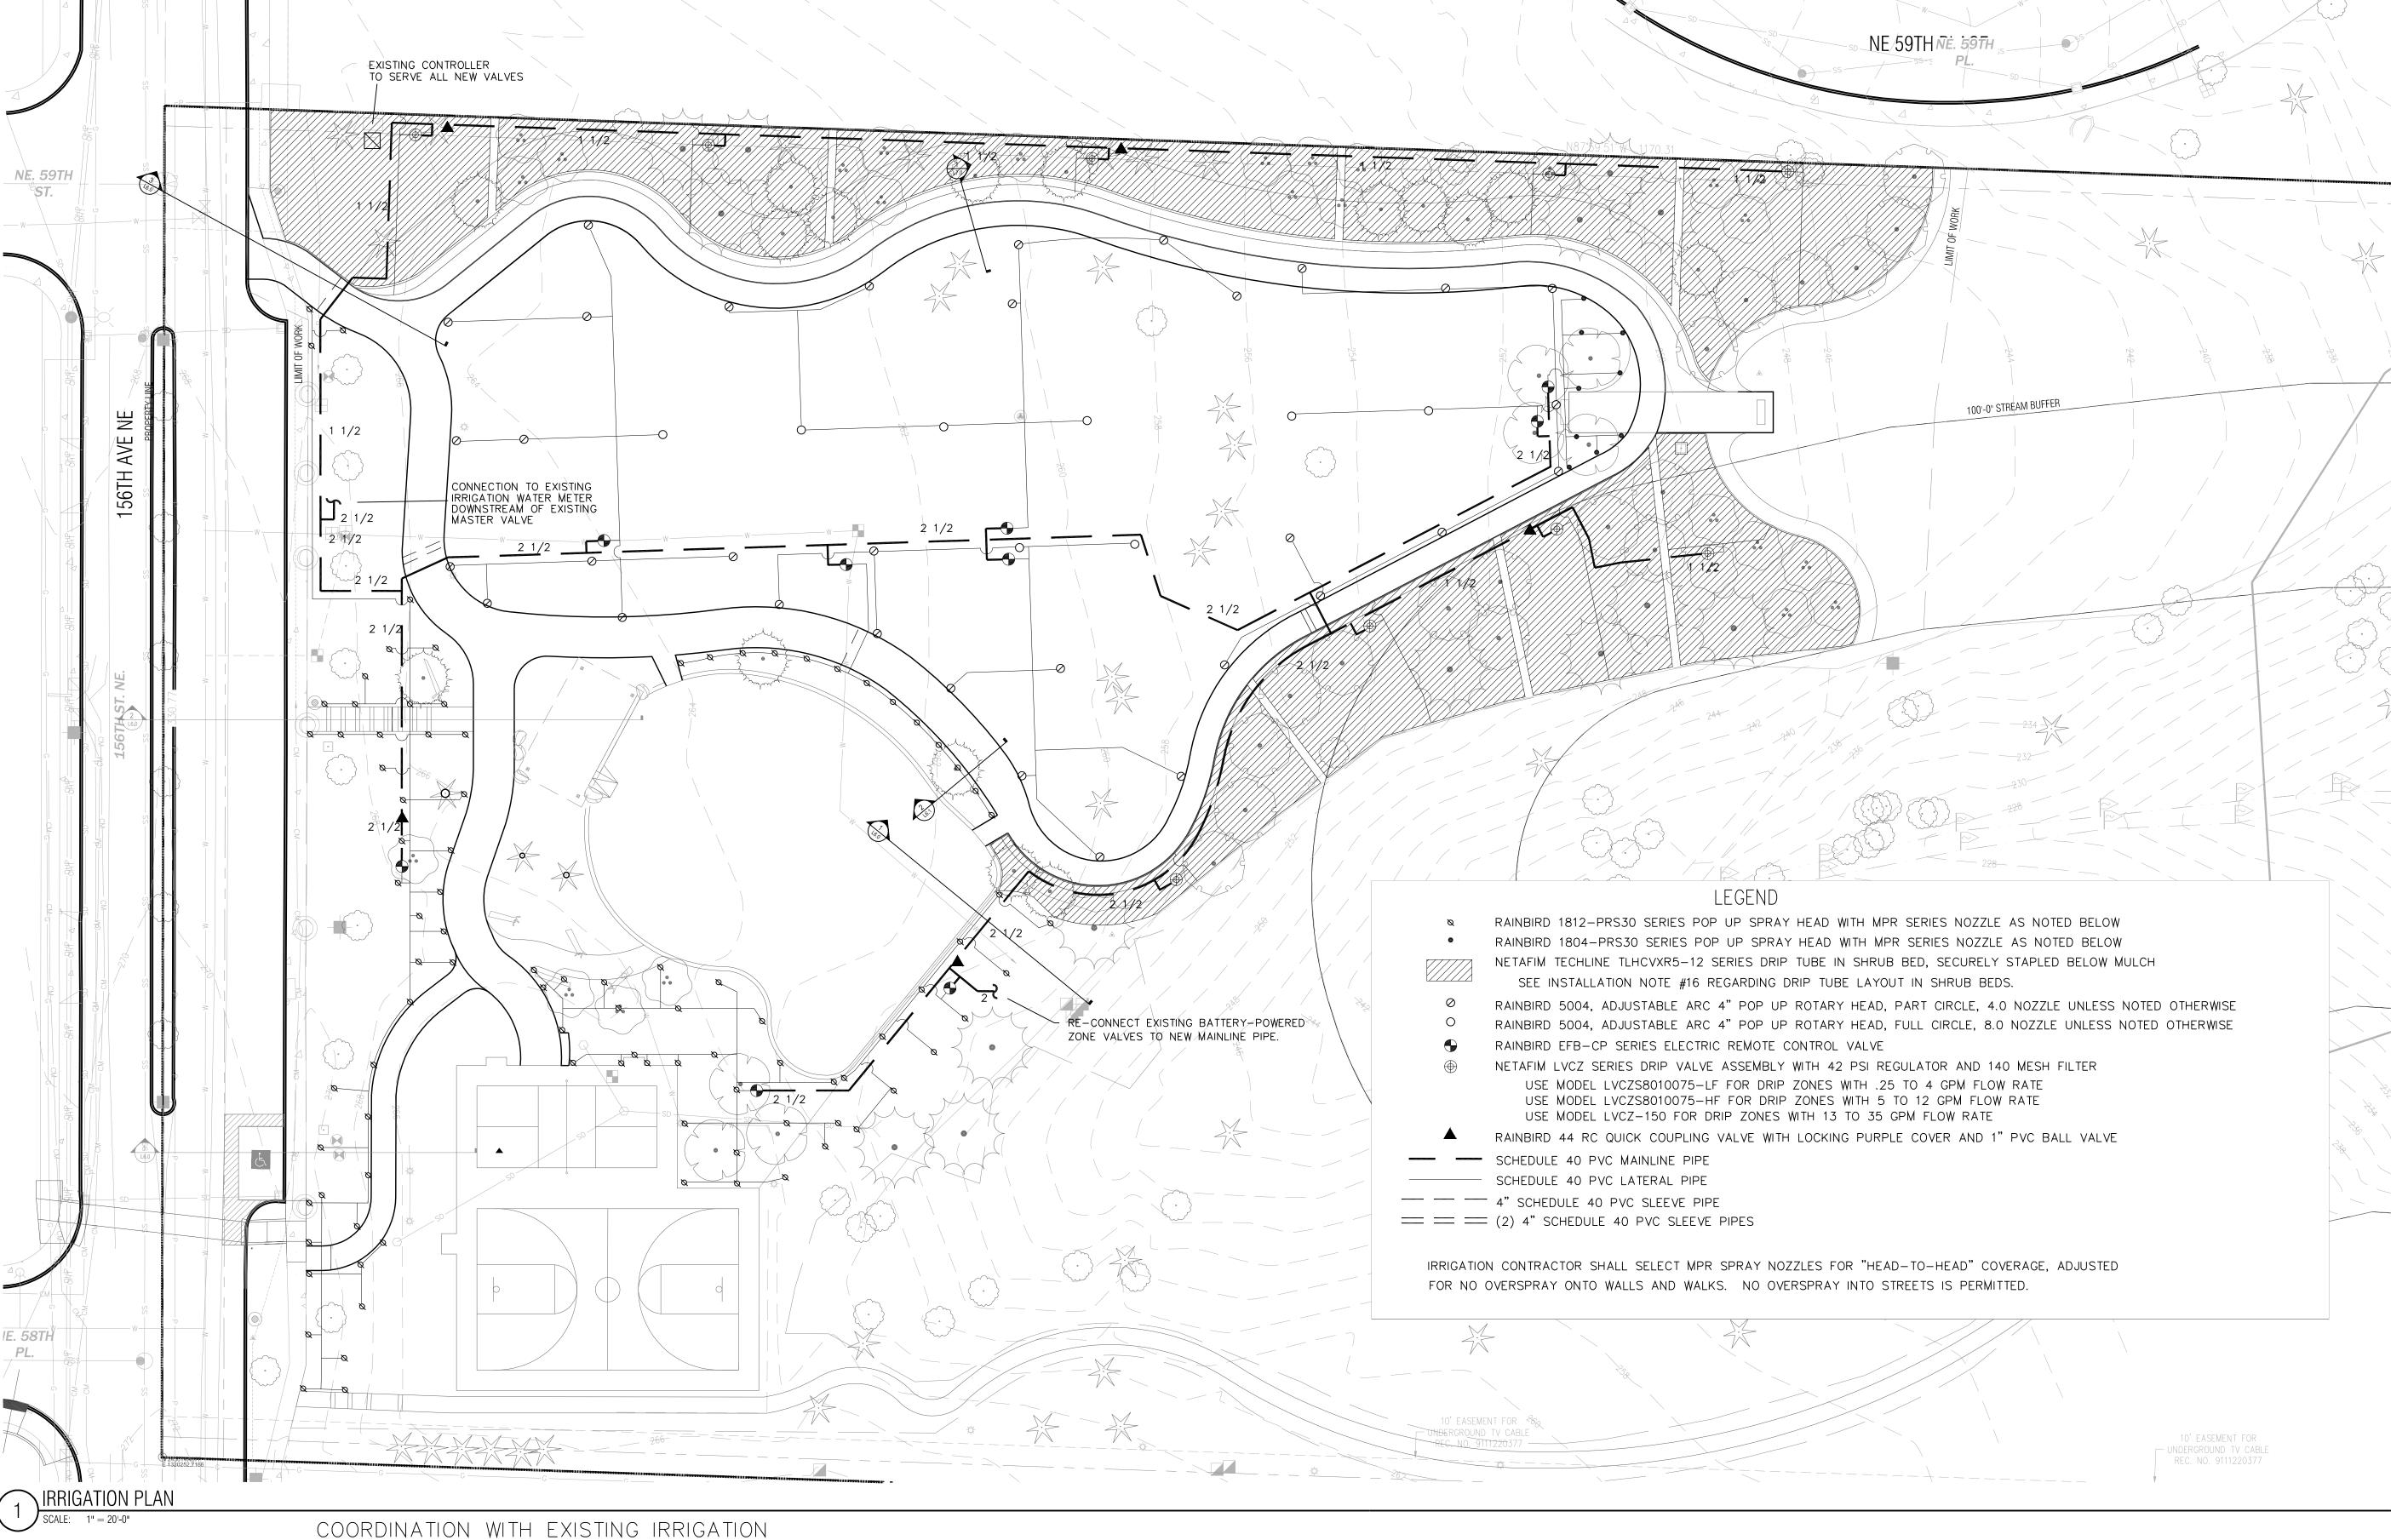

THE CONTRACTOR SHALL VISIT THE SITE BEFORE CONSTRUCTION BEGINS TO BECOME FAMILIAR WITH THE EXISTING SYSTEM LAYOUT. REPOUTE, REPAIR, OR REINSTALL EXISTING EQUIPMENT, INCLUDING MAINLINE AND CONTROL WIRES AS REQUIRED TO MAINTAIN CONTINUED AUTOMATIC OPERATION OF ALL AREAS OUTSIDE

THE LIMITS OF WORK. PROTECT EXISTING EQUIPMENT WITHIN THE LIMITS OF WORK, WHICH IS INTENDED TO REMAIN. SCHEDULE EXISTING BATTERY-POWERED ZONE VALVES TO AVOID SIMULTANEOUS OPERATION WITH OTHER VALVES.

COORDINATION WITH EXISTING TREES


NO MACHINE TRENCHING SHALL BE PERMITTED WITHIN THE ROOT ZONE OF EXISTING TREES. HAND-DIG ONLY, WITHIN THE ROOT ZONES OF EXISTING TREES. NO ROOTS OVER 1" DIAMETER SHALL BE CUT. STAKE ALL PROPOSED TRENCH ROUTES NEAR EXISTING TREES FOR APPROVAL BY THE LANDSCAPE ARCHITECT BEFORE DIGGING BEGINS.



DENTON, TEXAS 76201

IRRIGATION DESIGN, CONSULTING, AND LANDSCAPE WATER MANAGEMENT TEXAS L.I.C. #658 PHONE: 940.243.2364 100 N. LOCUST ST., SUITE 3 FAX: 940.382.2475

james@jamespoleirrigation.com

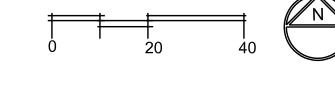

WaterSense

IRRIGATION IN TEXAS IS REGULATED BY THE TEXAS COMMISION ON ENVIRONMENTAL QUALITY (TCEQ) (MC-178) P.O. BOX 13087 T.C.E.Q.'S WEB SITE IS: WWW.TCEQ.STATE.TX.US

Approved for Construction

Steve Flude, P.E. City Engineer

THIS DEVELOPMENT SHALL BE CONSTRUCTED IN ACCORDANCE WITH THE 2020 CITY OF REDMOND STANDARD SPECIFICATIONS AND

DATE

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RENOVATI

REVISIONS DATE DESCRIPTION

ISSUANCES

DATE DESCRIPTION

02.26.2020 30% PLANS 04.20.2020 60% PLANS

04.30.2020 SITE PLAN ENTITLEMENT

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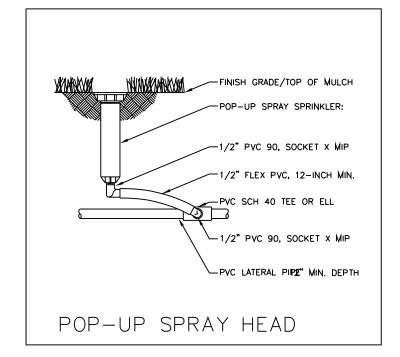
500021924 PROJECT #: PLOT DATE: 04.30.2020


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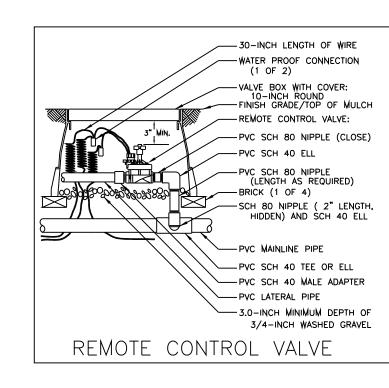
IRRIGATION PLAN


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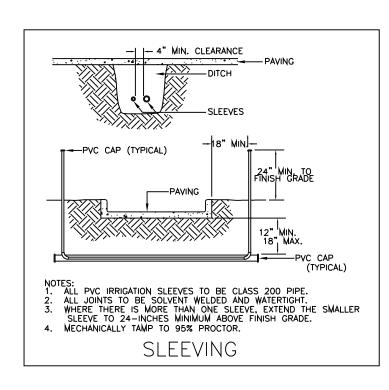
SHEET NO.: 27 OF 35










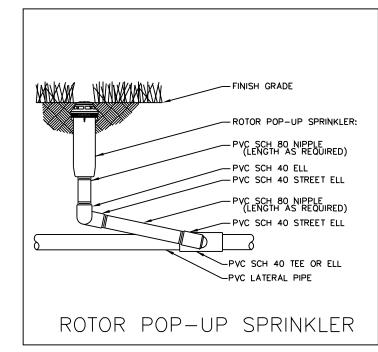


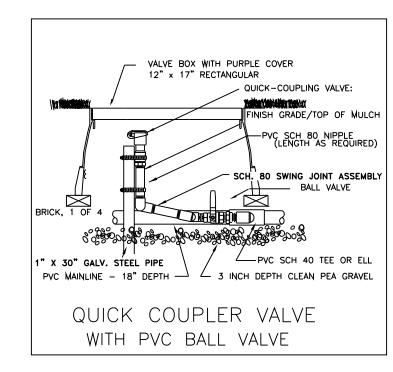


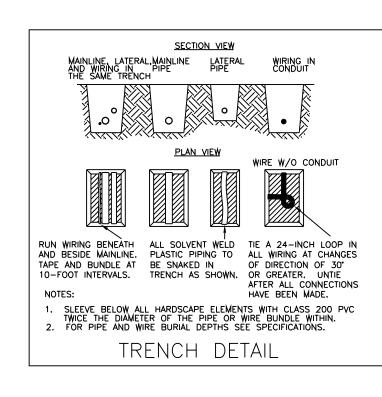


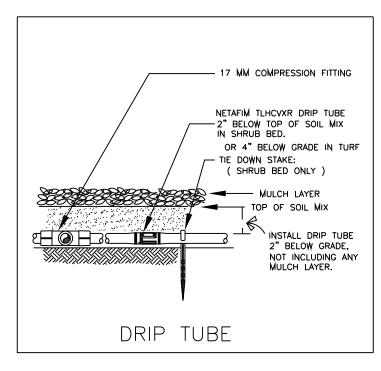


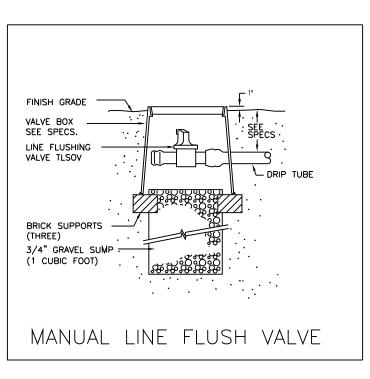


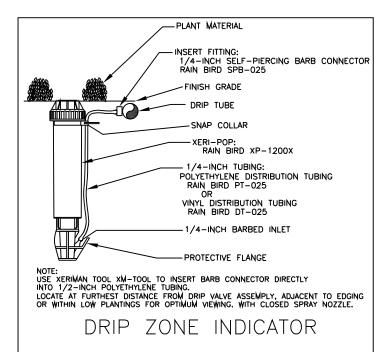

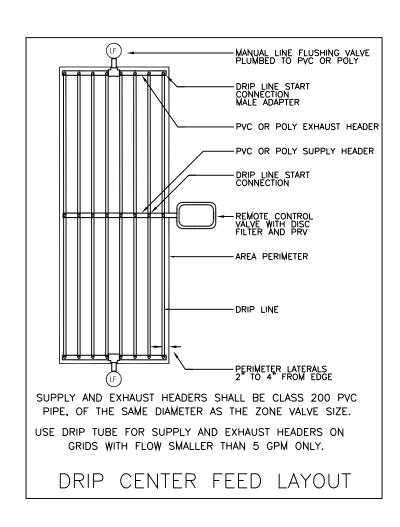

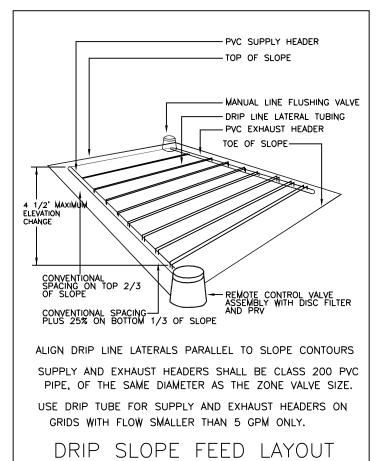

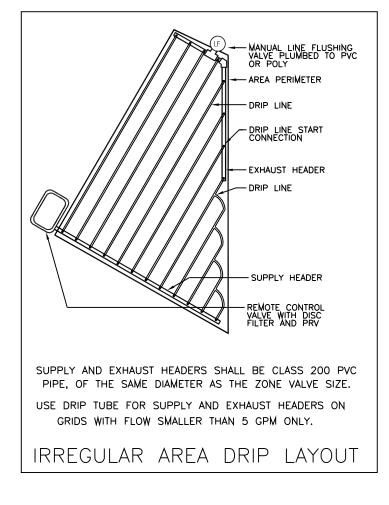

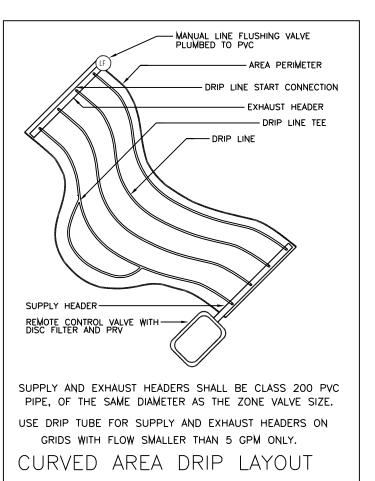

LEGEND

RAINBIRD 1812-PRS30 SERIES POP UP SPRAY HEAD WITH MPR SERIES NOZZLE AS NOTED BELOW
RAINBIRD 1804-PRS30 SERIES POP UP SPRAY HEAD WITH MPR SERIES NOZZLE AS NOTED BELOW

NETAFIM TECHLINE TLHCVXR5-12 SERIES DRIP TUBE IN SHRUB BED, SECURELY STAPLED BELOW MULCH

SEE INSTALLATION NOTE #16 REGARDING DRIP TUBE LAYOUT IN SHRUB BEDS.

RAINBIRD 5004, ADJUSTABLE ARC 4" POP UP ROTARY HEAD, PART CIRCLE, 4.0 NOZZLE UNLESS NOTED OTHERWISE RAINBIRD 5004. ADJUSTABLE ARC 4" POP UP ROTARY HEAD, FULL CIRCLE, 8.0 NOZZLE UNLESS NOTED OTHERWISE

RAINBIRD EFB-CP SERIES ELECTRIC REMOTE CONTROL VALVE

NETAFIM LVCZ SERIES DRIP VALVE ASSEMBLY WITH 42 PSI REGULATOR AND 140 MESH FILTER

USE MODEL LVCZS8010075-LF FOR DRIP ZONES WITH .25 TO 4 GPM FLOW RATE

USE MODEL LVCZS8010075-HF FOR DRIP ZONES WITH 5 TO 12 GPM FLOW RATE

USE MODEL LVCZ-150 FOR DRIP ZONES WITH 13 TO 35 GPM FLOW RATE

A RAINBIRD 44 RC QUICK COUPLING VALVE WITH LOCKING PURPLE COVER AND 1" PVC BALL VALVE

SCHEDULE 40 PVC MAINLINE PIPE

SCHEDULE 40 PVC LATERAL PIPE

4" SCHEDULE 40 PVC SLEEVE PIPE

(2) 4" SCHEDULE 40 PVC SLEEVE PIPES

IRRIGATION CONTRACTOR SHALL SELECT MPR SPRAY NOZZLES FOR "HEAD-TO-HEAD" COVERAGE, ADJUSTED FOR NO OVERSPRAY ONTO WALLS AND WALKS. NO OVERSPRAY INTO STREETS IS PERMITTED.

INSTALLATION NOTES

- 1. COORDINATE IRRIGATION INSTALLATION WITH PLANTING PLAN AND SITE CONDITIONS TO PROVIDE COMPLETE COVERAGE WITH MINIMUM OVERSPRAY. THE IRRIGATION CONTRACTOR SHALL MAKE MINOR ADJUSTMENTS TO ENSURE PROPER COVERAGE AT NO ADDITIONAL COST TO THE OWNER.

 THE IRRIGATION CONTRACTOR SHALL COMPLY WITH ALL LOCAL AND STATE MANDATED IRRIGATION ORDINANCES AND CODES, AND WILL SECURE ALL REQUIRED PERMITS. L.I.C. SHALL PAY ANY ASSOCIATED FEES UNLESS OTHERWISE NOTED. ALL LOCAL CODES SHALL PREVAIL OVER ANY DISCREPANCIES HEREIN AND SHALL BE ADDRESSED BEFORE ANY CONSTRUCTION BEGINS.
- 2. NO MACHINE TRENCHING SHALL BE PERMITTED WITHIN THE ROOT ZONE OF EXISTING TREES. HAND-DIG ONLY, WITHIN THE ROOT ZONES OF EXISTING TREES. NO ROOTS OVER 1" DIAMETER SHALL BE CUT. STAKE ALL PROPOSED TRENCH ROUTES NEAR EXISTING TREES FOR APPROVAL BY THE LANDSCAPE ARCHITECT BEFORE DIGGING BEGINS.
- 3. CONFIRM MINIMUM STATIC WATER PRESSURE OF 60 PSI AT THE HIGHEST ELEVATION OF THE SYSTEM LIMITS, AND MAXIMUM STATIC WATER PRESSURE OF 90 P.S.I. AT THE LOWEST ELEVATION OF THE SYSTEM LIMITS AT LEAST 7 DAYS BEFORE BEGINNING WORK. IF STATIC WATER PRESSURE IS OUTSIDE THE RANGE STATED ABOVE, DO NOT PROCEED UNTIL DIRECTED BY THE LANDSCAPE ARCHITECT.
- 4. LATERAL PIPE SHALL BE INSTALLED AT A MINIMUM DEPTH OF 12 INCHES. MAINLINE PIPE AND WIRES SHALL BE INSTALLED AT A MINIMUM DEPTH OF 18 INCHES. NO MACHINE TRENCHING SHALL BE PERMITTED WITHIN EXISTING TREE ROOT ZONES. WHEN HAND TRENCHING WITHIN EXISTING TREE ROOT ZONES, NO ROOTS LARGER THAN 1" DIAMETER SHALL BE CUT.
- 5. UNSLEEVED PIPES MAY BE SHOWN UNDER PAVEMENT FOR GRAPHIC CLARITY ONLY. INSTALL THESE PIPES IN ADJACENT LANDSCAPED AREAS.
- 6. COORDINATE LOCATION OF ALL VALVE BOXES WITH THE LANDSCAPE ARCHITECT
- 7. 24 VOLT VALVE WIRE SHALL BE A MINIMUM OF #14 GAUGE, U.F. APPROVED FOR DIRECT BURIAL, SINGLE CONDUCTOR "IRRIGATION WIRE". WIRE SPLICES SHALL INCLUDE DBY CONNECTORS AS MANUFACTURED BY 3M COMPANY. ALL FIELD SPLICES SHALL BE LOCATED IN A ROUND VALVE BOX OF SUFFICIENT SIZE TO ALLOW INSPECTION.
- 8. VALVE BOXES SHALL BE INSTALLED FLUSH WITH GRADE, SUPPORTED BY BRICKS IF NEEDED, WITH 3 INCHES
 OF CLEAN PEA GRAVEL LOCATED BELOW THE VALVE. USE 12" x 17" RECTANGULAR VALVE BOXES WITH PURPLE LID
 FOR QUICK COUPLING VALVES, AND 10" ROUND BOXES FOR ELECTRIC VALVES UNLESS NOTED OTHERWISE.
- 9. USE RIGID SCH. 80 PVC SWING JOINT ASSEMBLIES TO CONNECT ALL ROTARY HEADS AND QUICK COUPLERS.
- 10. ALL SPRAY HEADS SHALL BE CONNECTED WITH A 12" MINIMUM LENGTH OF 1/2" FLEX PVC. THE FLEX PVC SHALL BE SOLVENT WELDED TO SCHEDULE 40 PVC FITTINGS WITH WELD-ON #795 SOLVENT AND #P-70 PRIMER.
- 11. PROVIDE ONE QUICK COUPLER KEY WITH SWIVEL HOSE ELL FOR EVERY SIX Q.C. VALVES. (MINIMUM ONE SET).
- 12. CONTRACTOR IS TO CONTACT APPROPRIATE AUTHORITIES AND LOCATE ALL UTILITIES PRIOR TO CONSTRUCTION.
- 13. LATERAL PIPE TO TREE STREAM BUBBLER HEADS IS OMITTED FOR GRAPHIC CLARITY. CONNECT TREE BUBBLER HEADS TO VALVES AS SHOWN WITH CLASS 200 PVC PIPE SIZED TO ALLOW A MAXIMUM FLOW VELOCITY OF 5 FEET PER SECOND
- 14. THE PROPOSED LOCATIONS OF ALL ABOVE— GROUND EQUIPMENT INCLUDING BACKFLOW PREVENTORS, CONTROLLERS AND WEATHER SENSORS SHALL BE STAKED BY THE CONTRACTOR FOR APPROVAL BY THE LANDSCAPE ARCHITECT OR OWNER'S REPRESENTATIVE BEFORE THESE ITEMS ARE INSTALLED.
- 15. ALL HEADS SHALL BE INSTALLED A MINIMUM OF 4" FROM PAVEMENT EDGES. (6" OR GREATER WHERE REQUIRED BY LOCAL CODE)
 FINAL HEAD ADJUSTMENTS BY THE CONTRACTOR SHALL INCLUDE THE ADDITION OF CHECK VALVES WHERE NEEDED TO
 PREVENT EXCESSIVE LOW HEAD DRAINAGE. THE CONTRACTOR SHALL BUDGET FOR, AND INSTALL CHECK VALVES FOR UP
 10 % OF THE TOTAL NUMBER OF HEADS WHEN NEEDED, WITH NO ADDITIONAL COST TO THE OWNER.
- 16. WHERE SHOWN ON THE PLANS, MASS SHRUB / GROUNDCOVER BEDS SHALL INCLUDE NETAFIM TECHLINE TLHCVXR SERIES


 DRIP TUBE WITH PRE-INSTALLED .55 GPH DRIP EMITTERS AT 12" INTERVALS (TLHCVXR5-12), INSTALLED IN CENTER-FED GRIDS
 WITH ROWS SPACED 18" APART. INDIVIDUAL DRIP TUBE RUNS SHALL NOT EXCEED 150 L.F. PVC LATERAL "TRUNK" LINES SHALL
 BE INSTALLED 10" DEEP. DRIP TUBE SHALL BE SET BELOW MULCH LAYER,
 SECURELY STAKED EVERY 18". NETAFIM #TL050MFV-1 FLUSH VALVES SHALL BE INSTALLED AT THE FARTHEST
 POINTS FROM THE ZONE VALVE. USE 17 MM BARBED FITTINGS FOR DRIP LINE CONNECTIONS, SET THE MAXIMUM
 OPERATING PRESSURE AT 30 PSI. TECHLINE CV SHALL BE INSTALLED PERPENDICULAR TO SLOPE FACE. INSTALL
 TLCV IN-LINE CHECK VALVES FOR EVERY 4.5 FEET OF DRIP LINE ELEVATION CHANGE WITHIN THE ZONE. USE
 NETAFIM STAPLES (#TLS6) TO SECURE TUBING EVERY 18" EACH DRIP ZONE SHALL INCLUDE ONE MAINTENANCE "FLAG"
 WHICH SHALL CONSIST OF A 12" POP-UP SPRAY HEAD AND COMPLETELY CLOSED SPRAY NOZZLE. THE POP-UP HEAD
 SHALL BE CONNECTED TO THE DRIP ZONE PIPE, SET FLUSH WITH GRADE, AND LOCATED AT THE FARTHERST DISTANCE FROM
 THE DRIP VALVE ASSEMBLY. INSTALL THE "FLAG" HEAD ADJACENT TO EDGING OR IN LOW PLANTINGS FOR EASE OF VIEWING.

COORDINATION WITH EXISTING IRRIGATION

THE CONTRACTOR SHALL VISIT THE SITE BEFORE CONSTRUCTION BEGINS TO BECOME FAMILIAR WITH THE EXISTING SYSTEM LAYOUT. REROUTE, REPAIR, OR REINSTALL EXISTING EQUIPMENT, INCLUDING MAINLINE AND CONTROL WIRES AS REQUIRED TO MAINTAIN CONTINUED AUTOMATIC OPERATION OF ALL AREAS OUTSIDE THE LIMITS OF WORK. PROTECT EXISTING EQUIPMENT WITHIN THE LIMITS OF WORK, WHICH IS INTENDED TO REMAIN.

COORDINATION WITH EXISTING TREES

NO MACHINE TRENCHING SHALL BE PERMITTED WITHIN THE ROOT ZONE OF EXISTING TREES. HAND-DIG ONLY, WITHIN THE ROOT ZONES OF EXISTING TREES. NO ROOTS OVER 1" DIAMETER SHALL BE CUT. STAKE ALL PROPOSED TRENCH ROUTES NEAR EXISTING TREES FOR APPROVAL BY THE LANDSCAPE ARCHITECT BEFORE DIGGING BEGINS.

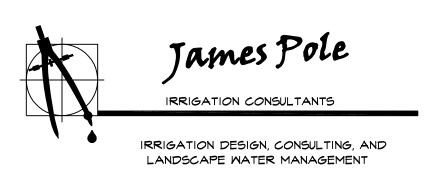

TEXAS L.I.C. #658 IOO N. LOCUST ST., SUITE 3 DENTON, TEXAS 7620I PHONE: 940.243.2364 FAX: 940.382.2475 james@jamespoleirrigation.com



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QUALITY (TCEQ) (MC-178) P.O. BOX 13087
T.C.E.Q.'S WEB SITE IS: WWW.TCEQ.STATE.TX.US

Approved for Construction

Steve Flude, P.E. City Engineer DATE

THIS DEVELOPMENT SHALL BE CONSTRUCTED IN ACCORDANCE WITH THE 2020 CITY OF REDMOND STANDARD SPECIFICATIONS AND DETAILS.

oard & Vellur 115 15th Ave E. Suite 100 Seattle, WA 98112

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REDMOND WESTSIDIRENOVATION
5810 156TH AVE NE

PAR

REVISIONS DATE DESCRIPTION

ISSUANCES

DATE

02.26.2020 30% PLANS

04.20.2020 60% PLANS

04.30.2020 SITE PLAN ENTITLEMENT

DESCRIPTION

COPYRIGHT BOARD AND VELLUM LLC. ALL RIGHTS RESERVED.
ORIGINAL SHEET SIZE IS 22*x34*

BOARD & VELLUM PROJECT #: 2019176.00

PROJECT #: 500021924

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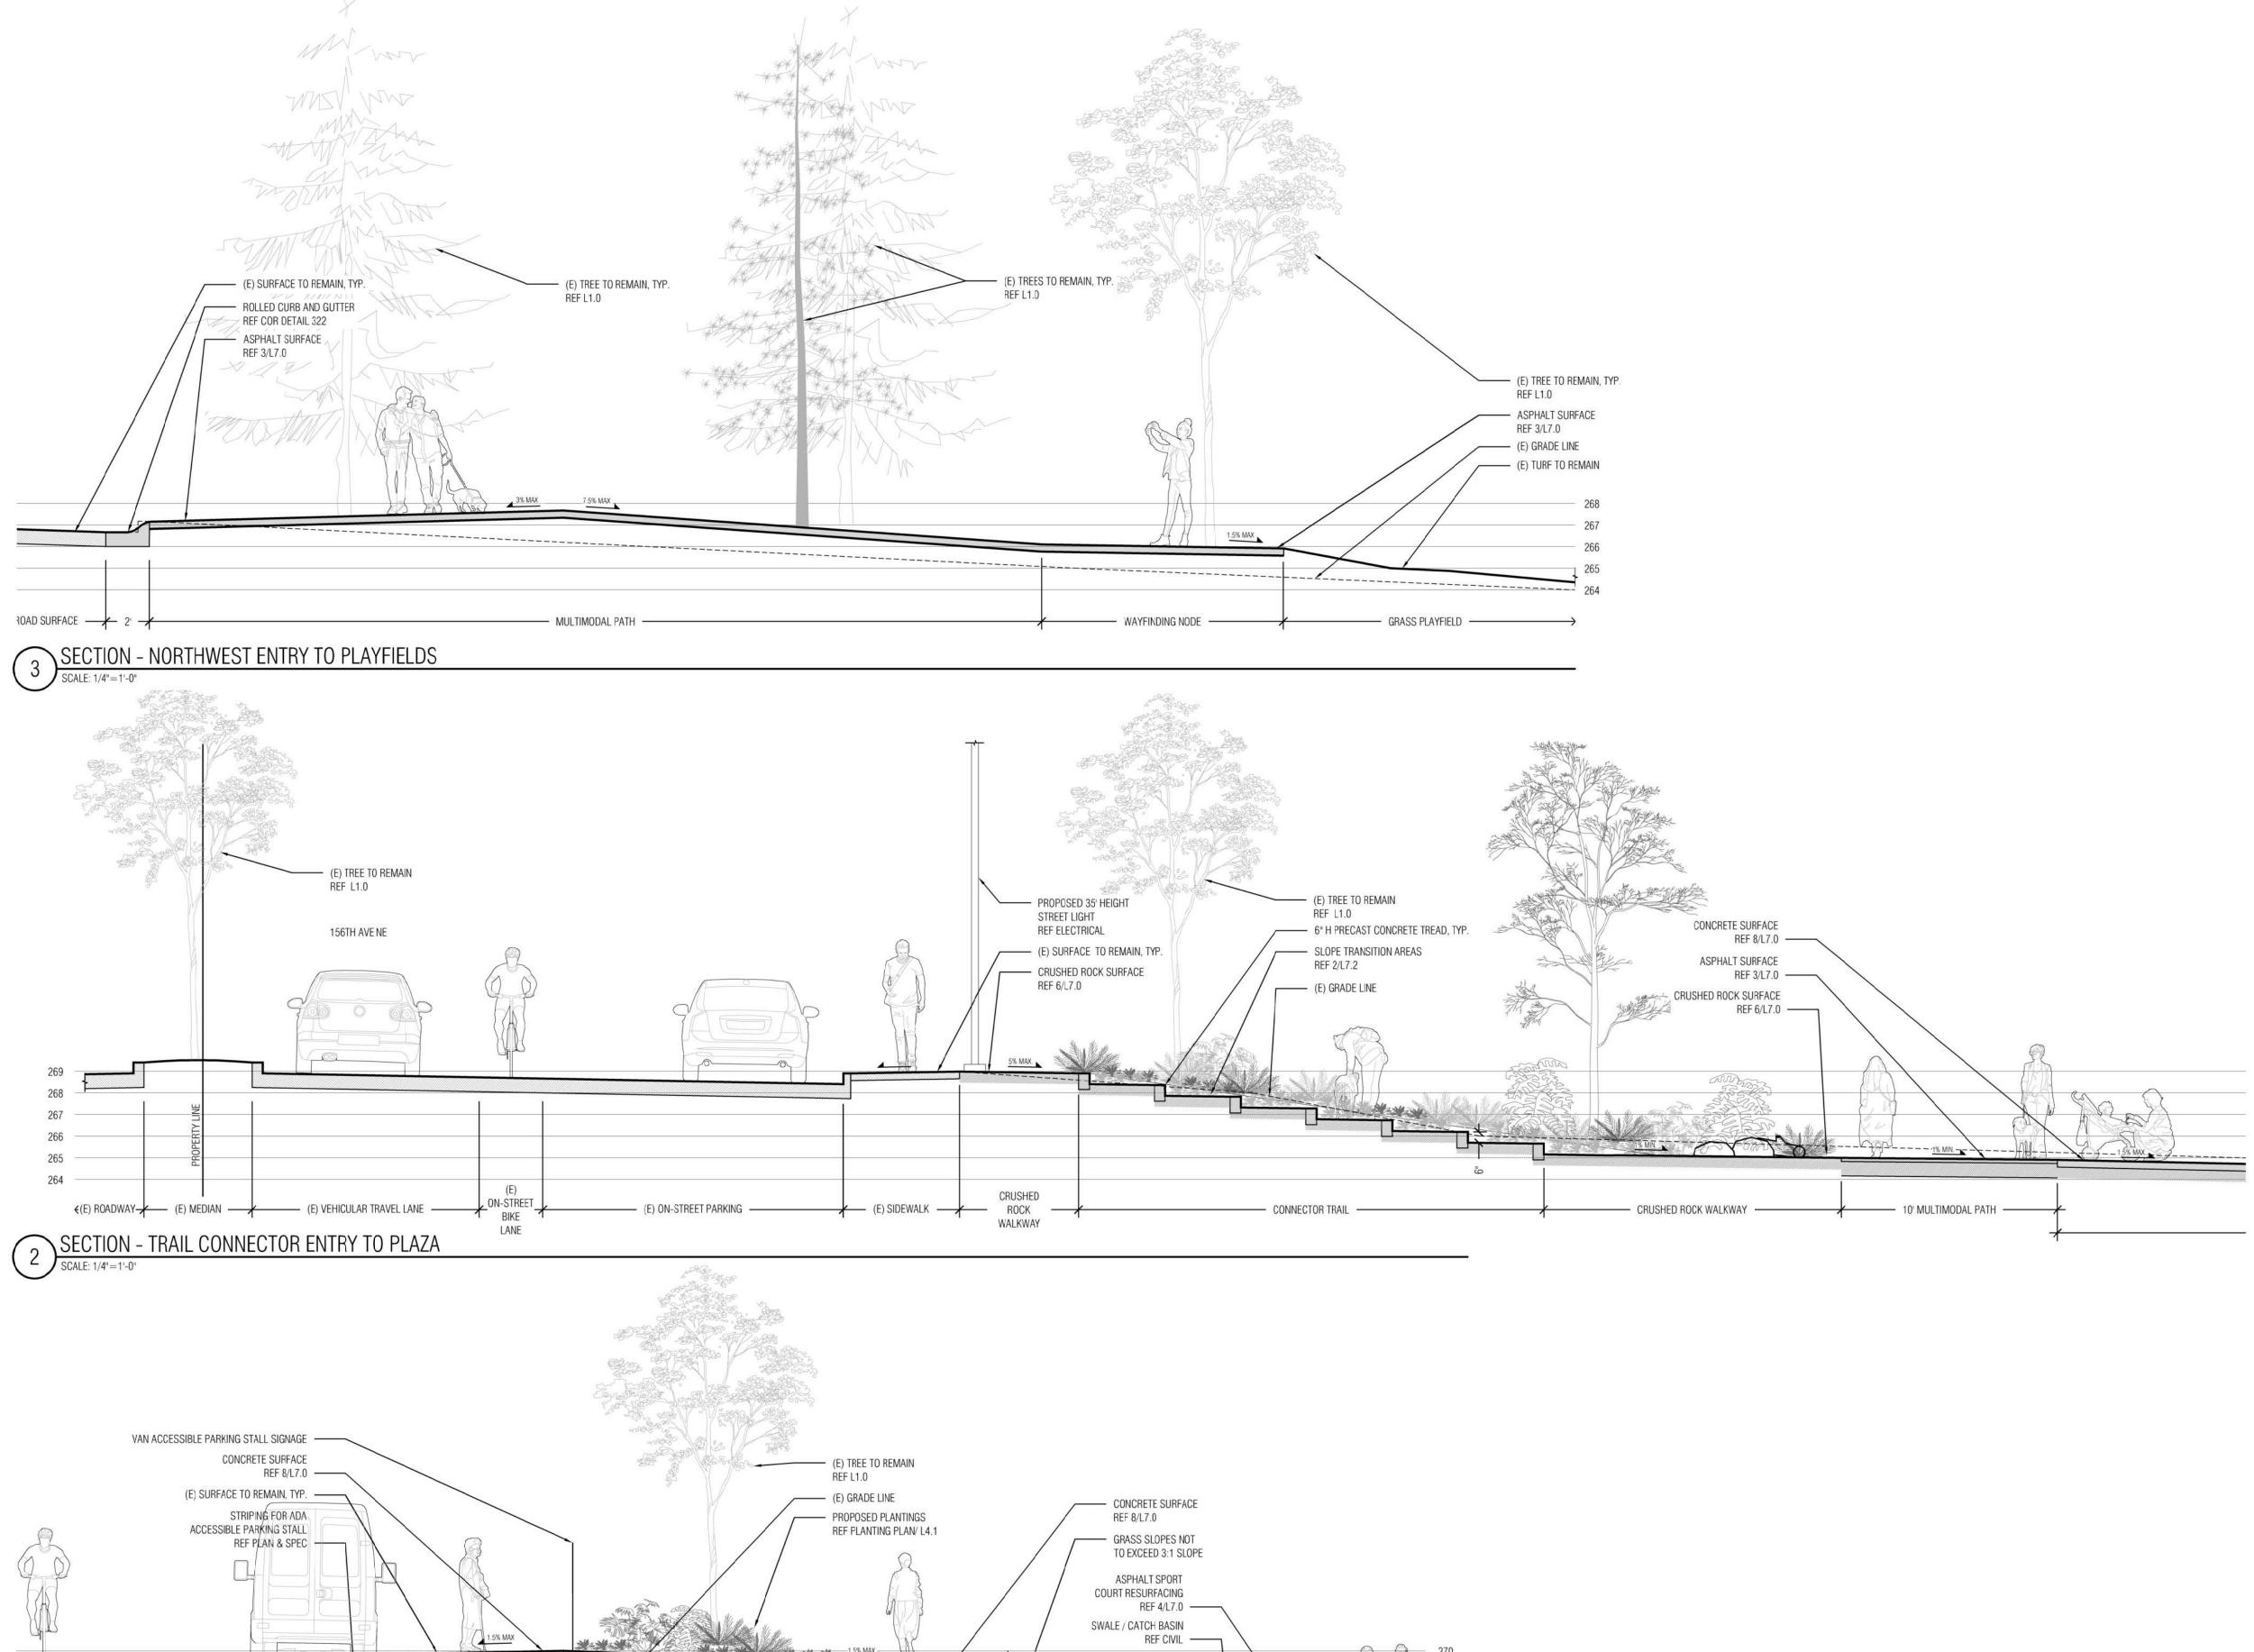
PLOT DATE: 04.30.2020

SHEET:

IRRIGATION DETAILS

L5.1

SHEET NO.: 28 0 35



GRASS AREA ----

6' ADA ACCESSIBLE

PEDESTRAIN ROUTE

— BUTTERFLY GARDEN ———

ON-STREET 3' ACCESS 11' ADA VAN ACCESSIBLE PARKING STALL EX. SIDEWALK 3' ADA TO REMAIN ACCESS PATH

SECTION - SOUTHWEST ENTRY TO SPORT COURT

265

→ SPORT COURT →

Approved for Construction

Steve Flude, P.E. City Engineer DATE

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Soard & Vellum
115 15th Ave E. Suite 100 Seattle, WA 98112





REDMOND WESTSIDE PARENOVATION 5810 156TH AVE NE BEDMOND, WA 98052

REVISIONS DATE DESCRIPTION

ISSUANCES

DATE DESCRIPTION

02.26.2020 30% PLANS

04.20.2020 60% PLANS

04.30.2020 SITE PLAN ENTITLEMENT

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BOARD & VELLUM PROJECT #: 2019176.00 PROJECT #: 500021924

PLOT DATE: 04.30.2020

SHEET:

SECTIONS L6.0

SHEET NO.: 29 OF 35


PLAY AREA ADVENTURE LOOP

SECTION - PLAY TO BIORETENTION

BIORETENTION FACILITY PER COR DETAIL 655, 657 REF CIVIL FOR DRAINAGE

── RESTORATION AREA ─────



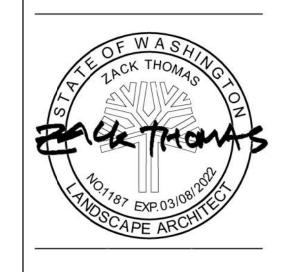



MOND WESTSIDE PARK IOVATION

REVISIONS DATE DESCRIPTION

ISSUANCES

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 DESCRIPTION

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 30% PLANS

04.20.2020 60% PLANS

04.30.2020 SITE PLAN ENTITLEMENT

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PROJECT #: 500021924

PLOT DATE: 04.30.2020

SHEET:

SECTIONS L6.1


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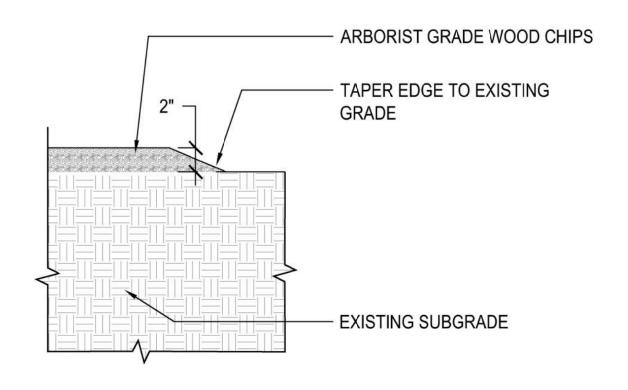
Approved for Construction


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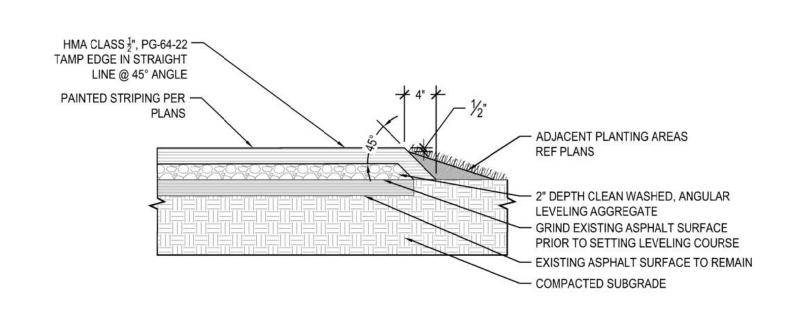


8 CONCRETE SURFACE
SCALE: NTS

SOFT SURFACE MATERIAL

6 CRUSHED ROCK SURFACE

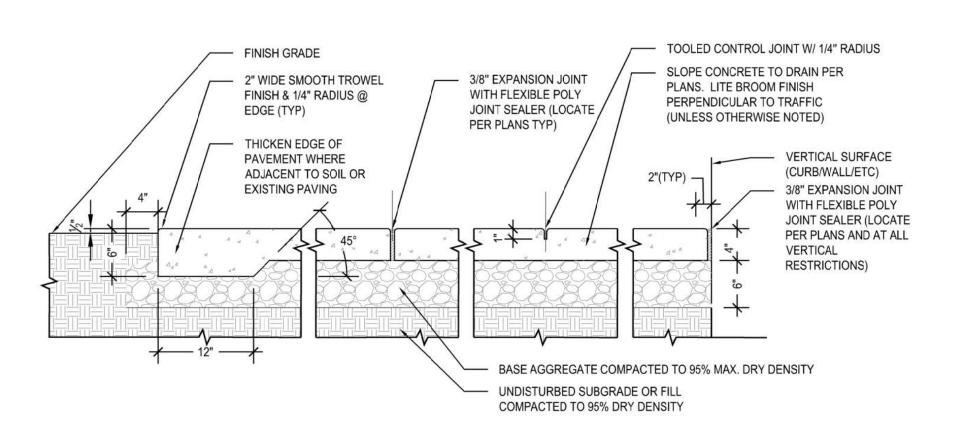 REFER TO DISTRIBUTOR FOR PRODUCT INFORMATION AND INSTALLATION GUIDES 2. KEVIN PFEIFER @ GEOTEK. 360.750.1955 ALIGN ROLLS ALONG SNAP FIT CONNECTIONS REINFORCEMENT RING SEE ENLARGEMENTS BELOW - REFER TO ENLARGEMENTS BELOW FOR PRODUCT SPECIFIC FILL MEDIUM BOTTOM OF REINFORCEMENT GRID SECTION - 6" COMPACTED GRAVEL SUBBASE REF FULL TECHNICAL SPECS FOR COMPOSITION - COMPACTED SUBGRADE - TOP OF GRAVEL; ALWAYS FLUSH WITH ADJACENT SURFACE GRAVELPAVE2: **ENLARGEMENT** - ATTACH ROLLS WITH PROVIDED SNAP FIT FASTENERS FILL RING SECTION WITH $\frac{3}{8}$ " TO $\frac{3}{16}$ " ANGULAR GRAVEL, NO FINES - COMPACTED GRAVEL SUBBASE AS SPECIFIED ABOVE TOP OF ROOTMASS ¹/₄" ABOVE GRASSPAVE RING GRASSPAVE2: ATTACH ROLLS WITH PROVIDED **ENLARGEMENT** SNAP FIT FASTENERS FILL RING SECTION WITH CLEAN, SHARP SAND - SEED MIX PER PLAN AND SPECIFICATION TOP OF GRASSPAVE RING ¹/₄" BELOW ADJACENT SURFACE - COMPACTED GRAVEL SUBBASE AS SPECIFIED ABOVE GRAVELPAVE AND GRASSPAVE

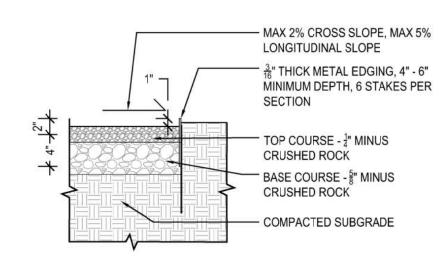

ADJACENT PAVING, SET ASPHALT
FLUSH TO FINISH SURFACE OF PAVING

HMA CLASS ½", PG-64-22
TAMP EDGE IN STRAIGHT LINE @ 45° ANGLE

ADAJACENT NON-PAVED AREA, SET 1/2"
BELOW FINISH SURFACE OF ASPHALT

4" DEPTH BASE AGGREGATE

COMPACTED SUBGRADE

ASPHALT SPORT COURT RESURFACING

SCALE: 1" = 11-0"

ASPHALT SURFACE

1. NO HEAVY MACHINERY SHALL BE USED WITHIN ANY TREE DRIPLINE. ALL WORK WITHIN DRIPLINES SHALL BE PERFORMED MANUALLY AS POSSIBLE. IF HEAVY MACHINERY MUST BE USED, 3" COARSE MULCH COVERED WITH PLYWOOD SHALL BE USED TO PROTECT AREAS WITHIN THE DRIPLINE FROM COMPACTION AND DAMAGE. 10' - 0" ─ VEGETATED FLOW PATH — VARIES - GRAVELPAVE; REF 5/L7.0 —— 6'-0"ASPHALT TRAIL; REF 3/L7.0 — REF CIVIL — 2'-0" DISPERSION TRENCH — ADAJACENT 1.5% MIN. 1.5% MAX. NON-PAVED AREA, SET 1/2" BELOW FINISH SURFACE OF **ASPHALT** - WHEN ENCOUNTERING EXISTING TREE ROOTS REF ARBORIST REPORT DRIVE HAMMER ANCHORS - WHEN ENCOUNTERING - DRIVE HAMMER ANCHORS INTO $\frac{3}{4}$ "-1.5" CLEAN WASHED - GRAVELPAVE HMA CLASS ¹₂, PG 64-22, ——— **EXISTING TREE ROOTS** SUBBASE AT 12" O.C. ALONG FINISHED INTO ASPHALT AND SUBBASE TAMP EDGE IN STRAIGHT ANGULAR GRAVEL REF ARBORIST REPORT EDGE ADJACENT TO PLANTING, TYP. WITH 20% SAND (PER AT 12" O.C. ALONG ENTIRE LINE @ 45° ANGLE AVOID ALL TREE ROOTS MANUFACTURER), LENGTH OF ASPHALT EDGE. 8" DEPTH BASE AASHTO 57 ----AVOID ALL TREE ROOTS. COMPACTED FINISH EDGE SHOULD BE AGGREGATE PER COMPLETE GRAVELPAVE RING — 6" TAPERED EDGE FOR GEOTECHNICAL ENGINEER GRAVELPAVE ANCHORS COMPACTED SUBGRADE -

Approved for Construction

Steve Flude, P.E. City Engineer

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DATE

Board & Vellui





REDMOND WESTSIDE PARK RENOVATION 5810 156TH AVENE

REVISIONS DATE DESCRIPTION

DATE DESCRIPTION

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04.30.2020 SITE PLAN ENTITLEMENT

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BOARD & VELLUM PROJECT #: 2019176.00


PROJECT #: 500021924


PLOT DATE: 04.30.2020

SHEET:

DETAILS L7.0

SHEET NO.: 31 OF 35

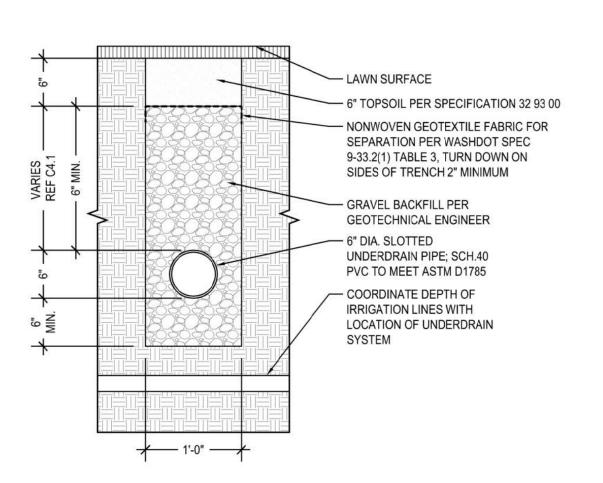

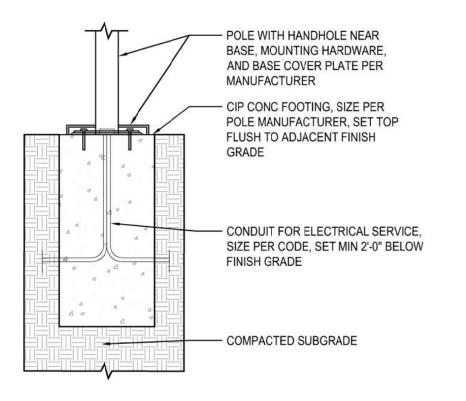

6"Ø SCH. 40 STEEL POST FOR 3/16" BACKSTOP PLAY SURFACE, SEE DETAIL XXX — 3,000 PSI CONC FOOTING TYPE 2 CRUSHED ROCK BASE COMPACTED SUBGRADE 36" Ø

NOTE: CONTRACTOR MAY CHOOSE TO INSTALL 8" DIA GALV STEEL PIPE SLEEVE 4'-6" LONG IN CONC FOUNDATION, THEN GROUT POST INTO PIPE AND WELD THE CONNECTION AS SHOWN


8 LAWN AREA DRAINAGE TRENCH

STREET LIGHT POLE FOOTING

BASKETBALL POST FOOTING

- SALVAGED LOG, SET MIN 2" INTO CRUSHED ROCK BASE COURSE - #5 REBAR, 4-'0" O.C., SET TOP MIN 1" BELOW TOP OF LOG MINERAL AGGREGATE BASE COURSE, SET WIDTH APPROXIMATELY EQUAL TO WIDTH OF THE LOG — MULCH


- BOULDER, SET MIN 2" INTO CRUSHED ROCK BASE COURSE MINERAL AGGREGATE BASE COURSE, SET WIDTH APPROXIMATELY EQUAL TO WIDTH OF THE BOULDER

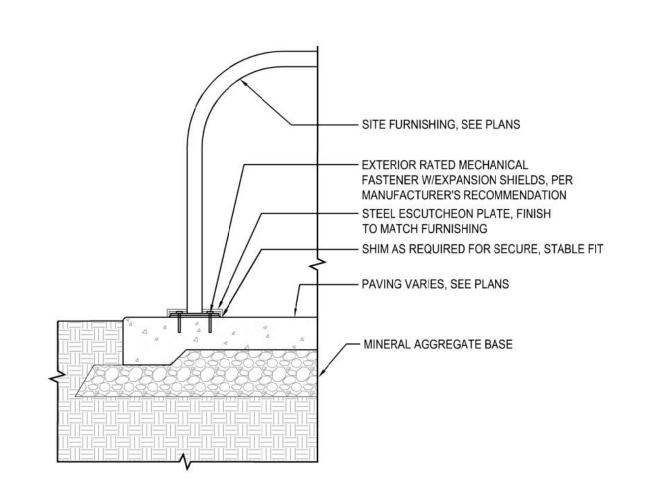


SALVAGED LOG

\PLAY AREA CURB

SITE FURNISHING ATTACHMENT

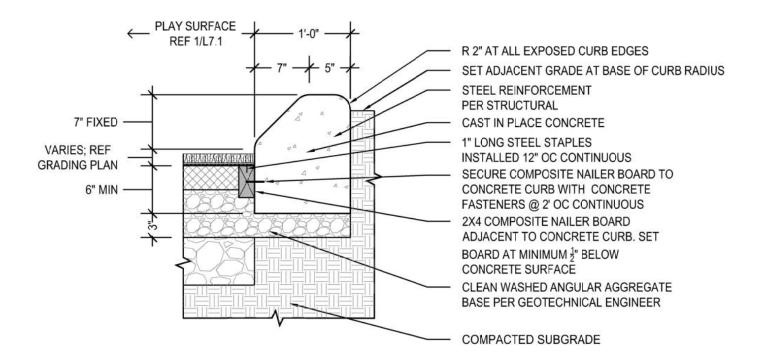

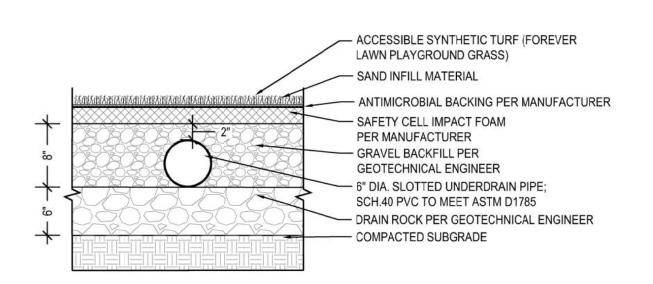

Approved for Construction

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SHEET: **DETAILS** L7.1

CityofRedmond

PARK

) WESTSIDE ION

REDMOND RENOVATIO

REVISIONS DATE

ISSUANCES

PROJECT #:

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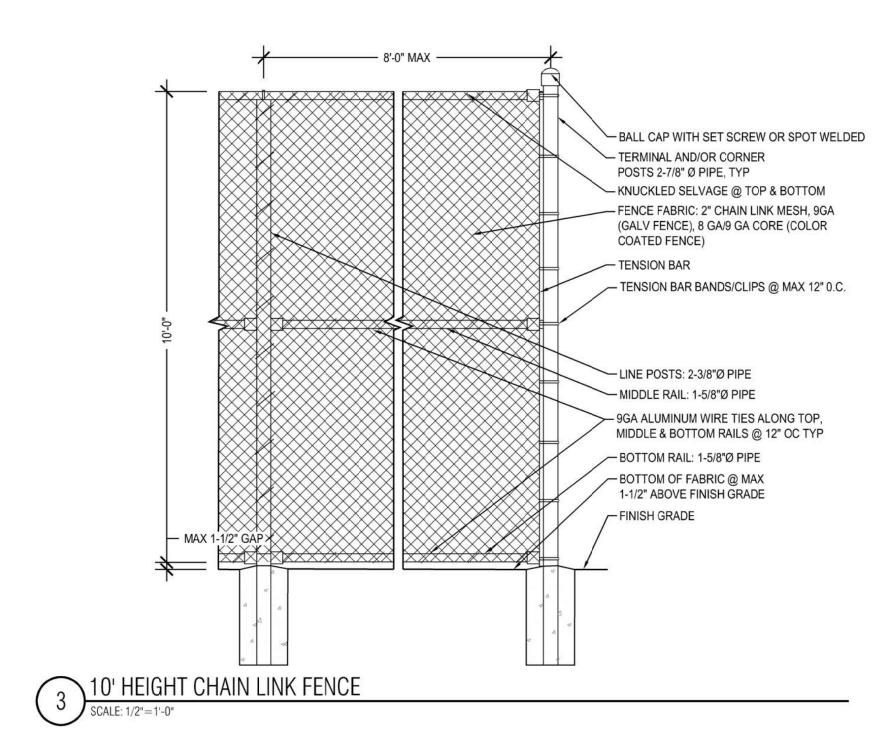
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04.30.2020


DESCRIPTION

32 OF 35 SHEET NO .:

Steve Flude, P.E. City Engineer DATE



TOP RAIL: 2 X4 WOOD - POST CAP: DECORATIVE WOOD CAP - POST: 4X4 POST-ON-PIPE AS SUPPLIED BY CITYWIDE FENCE, OR APPROVED EQUAL - PANEL: 3.5 GAUGE 4 X 4 SQUARE GRID WIRE PANEL WITH WELDED JOINTS, HOT DIP GALV FINISH, AS SUPPLIED BY DUNN LUMBER OR APPROVED EQUAL - PANEL FRAME: 5/4 X 3 WOOD, BOTH SIDES OF FENCE PANEL - SLOPE TOP OF FOOTING TO DRAIN 1" GAP, TYP - COMPACTED SUBGRADE NOTE: ALL WOOD TO BE SMOOTH MILLED CEDAR OR SIMILARLY WEATHER +1'-0"Ø RESISTANT SPECIES, USE SAME WOOD SPECIES FOR ALL PARTS

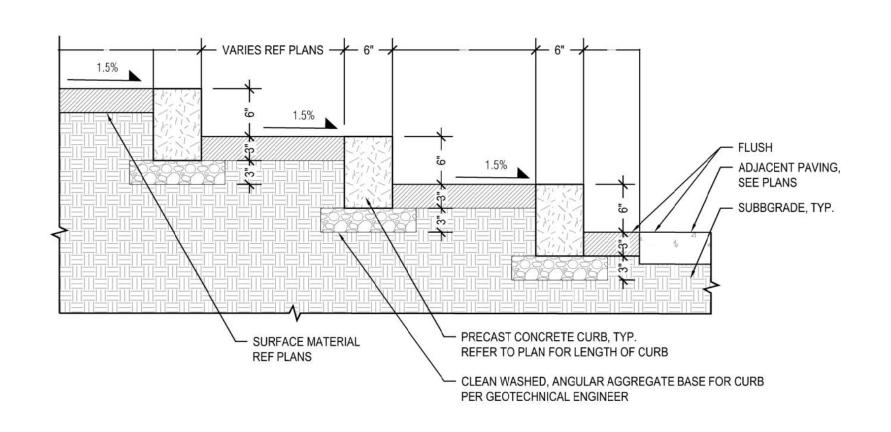

2 SLOPE TRANSITION AREAS

SCALE: 1"=1'-0"

Approved for Construction

Steve Flude, P.E. City Engineer DATE

THIS DEVELOPMENT SHALL BE CONSTRUCTED IN ACCORDANCE WITH THE 2020 CITY OF REDMOND STANDARD SPECIFICATIONS AND DETAILS.

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REDMOND WESTSIDE PARK
RENOVATION
5810 156TH AVE NE
REDMOND, WA 98052
OWNER:

REVISIONS DATE DESCRIPTION

ISSUANCES

 DATE
 DESCRIPTION

 02.26.2020
 30% PLANS

04.20.2020 60% PLANS

04.30.2020 SITE PLAN ENTITLEMENT

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BOARD & VELLUM PROJECT #: 2019176.00 PROJECT #: 500021924

PLOT DATE: 04.30.2020

SHEET:

DETAILS L7.2

SHEET NO.: 33 OF 35

LOW FENCING
SCALE: 1/2"=1'-0"



REDMOND WESTSIDE PARK
RENOVATION

REVISIONS DATE DESCRIPTION

ISSUANCES

DATE DESCRIPTION 02.26.2020 30% PLANS

04.20.2020 60% PLANS 04.30.2020 SITE PLAN ENTITLEMENT


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BOARD & VELLUM PROJECT #: 2019176.00 500021924 PROJECT #: 04.30.2020 PLOT DATE:

SHEET:


DETAILS L7.3

SHEET NO.: 34 OF 35

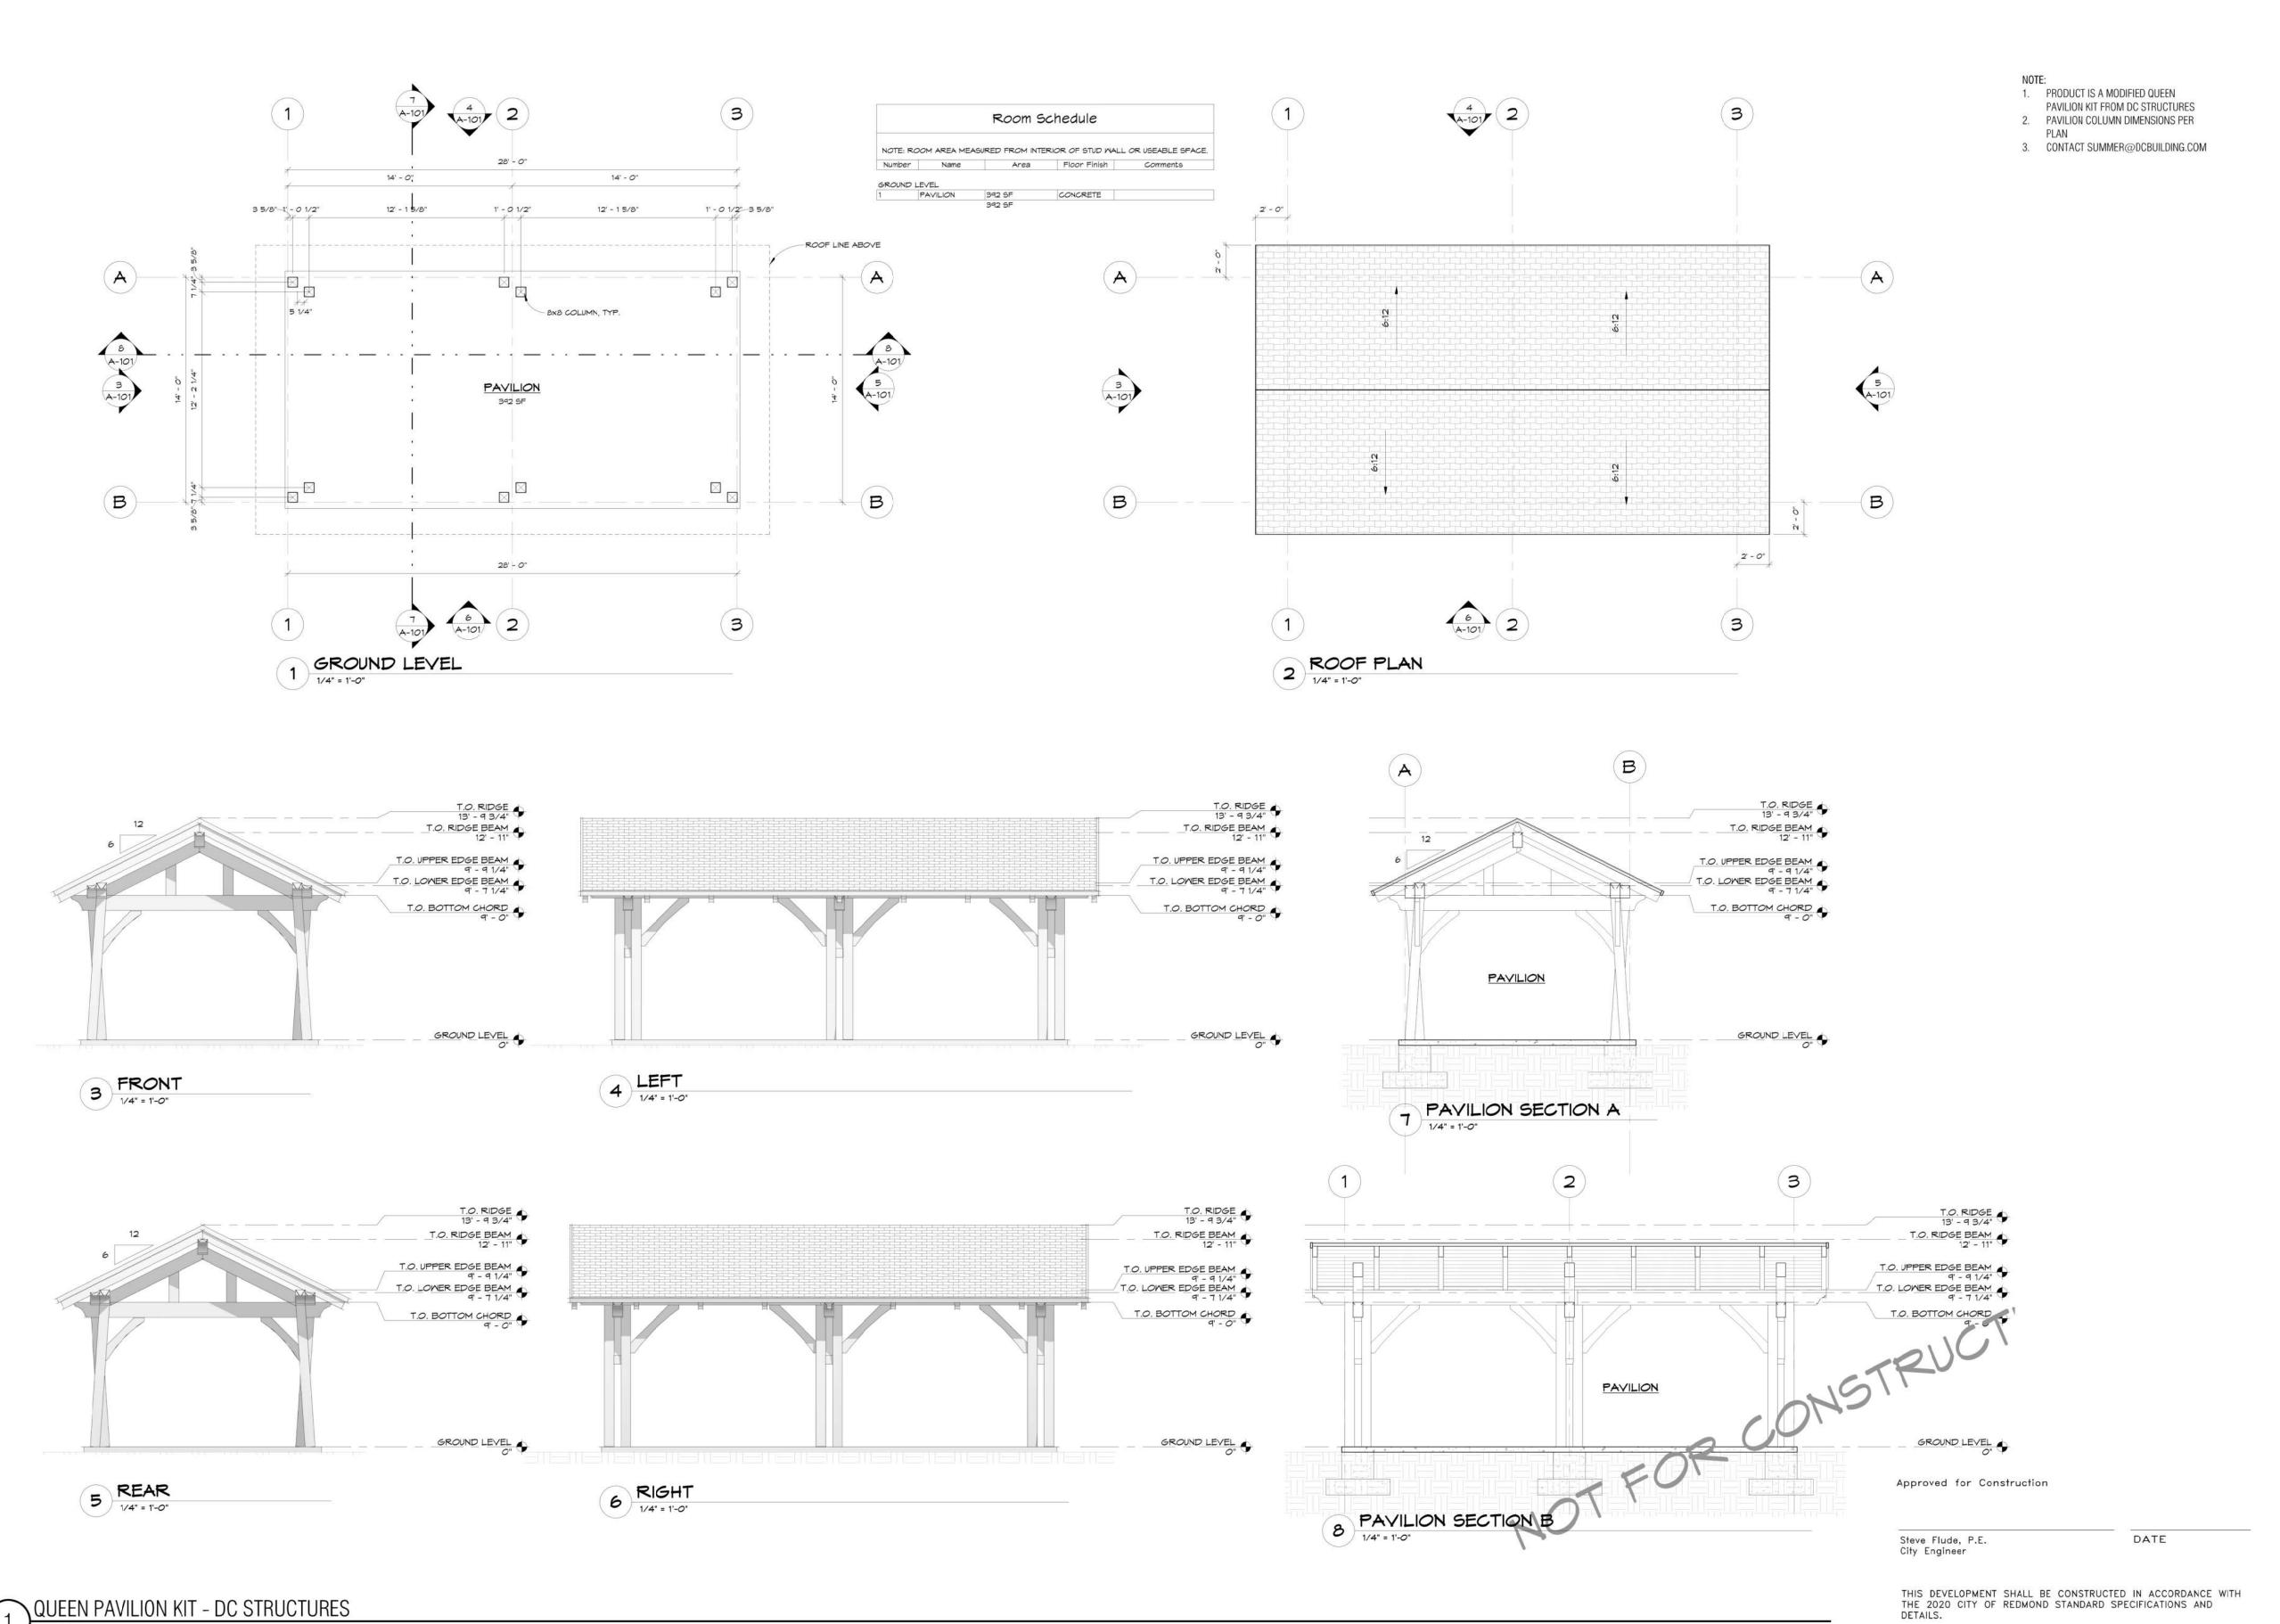

Luminaire S	chedule						
Symbol	Qty	Label	Arrangement	LLF	Description	Lum. Watts	Lum. Lumens
+	3	S1	SINGLE	0.850	ERL1-0-08-C3-30-D-GRAY (GE EVOLVE SERIES)	71	7800
-	1	EX	SINGLE	0.720	Existing 100w HPS Cobrahead	297	6541
+	1	S2	SINGLE	0.850	ERL1-0-10-C3-30-D-GRAY (GE EVOLVE SERIES)	97	9600

Calculation Summary							
Label	CalcType	Units	Avg	Max	Min	Avg/Min	Max/Min
58TH ST INTERSECTION_Planar	Illuminance	Fc	0.92	1.6	0.4	2.13	4.00
59TH ST INTERSECTION_Planar	Illuminance	Fc	1.15	2.5	0.5	2.30	5.00
ROADWAY 156TH_Planar	Illuminance	FC	0.73	2.4	0.4	1.83	6.00
SIDEWALK_Planar	Illuminance	Fc	0.75	1.5	0.4	1.88	3.75

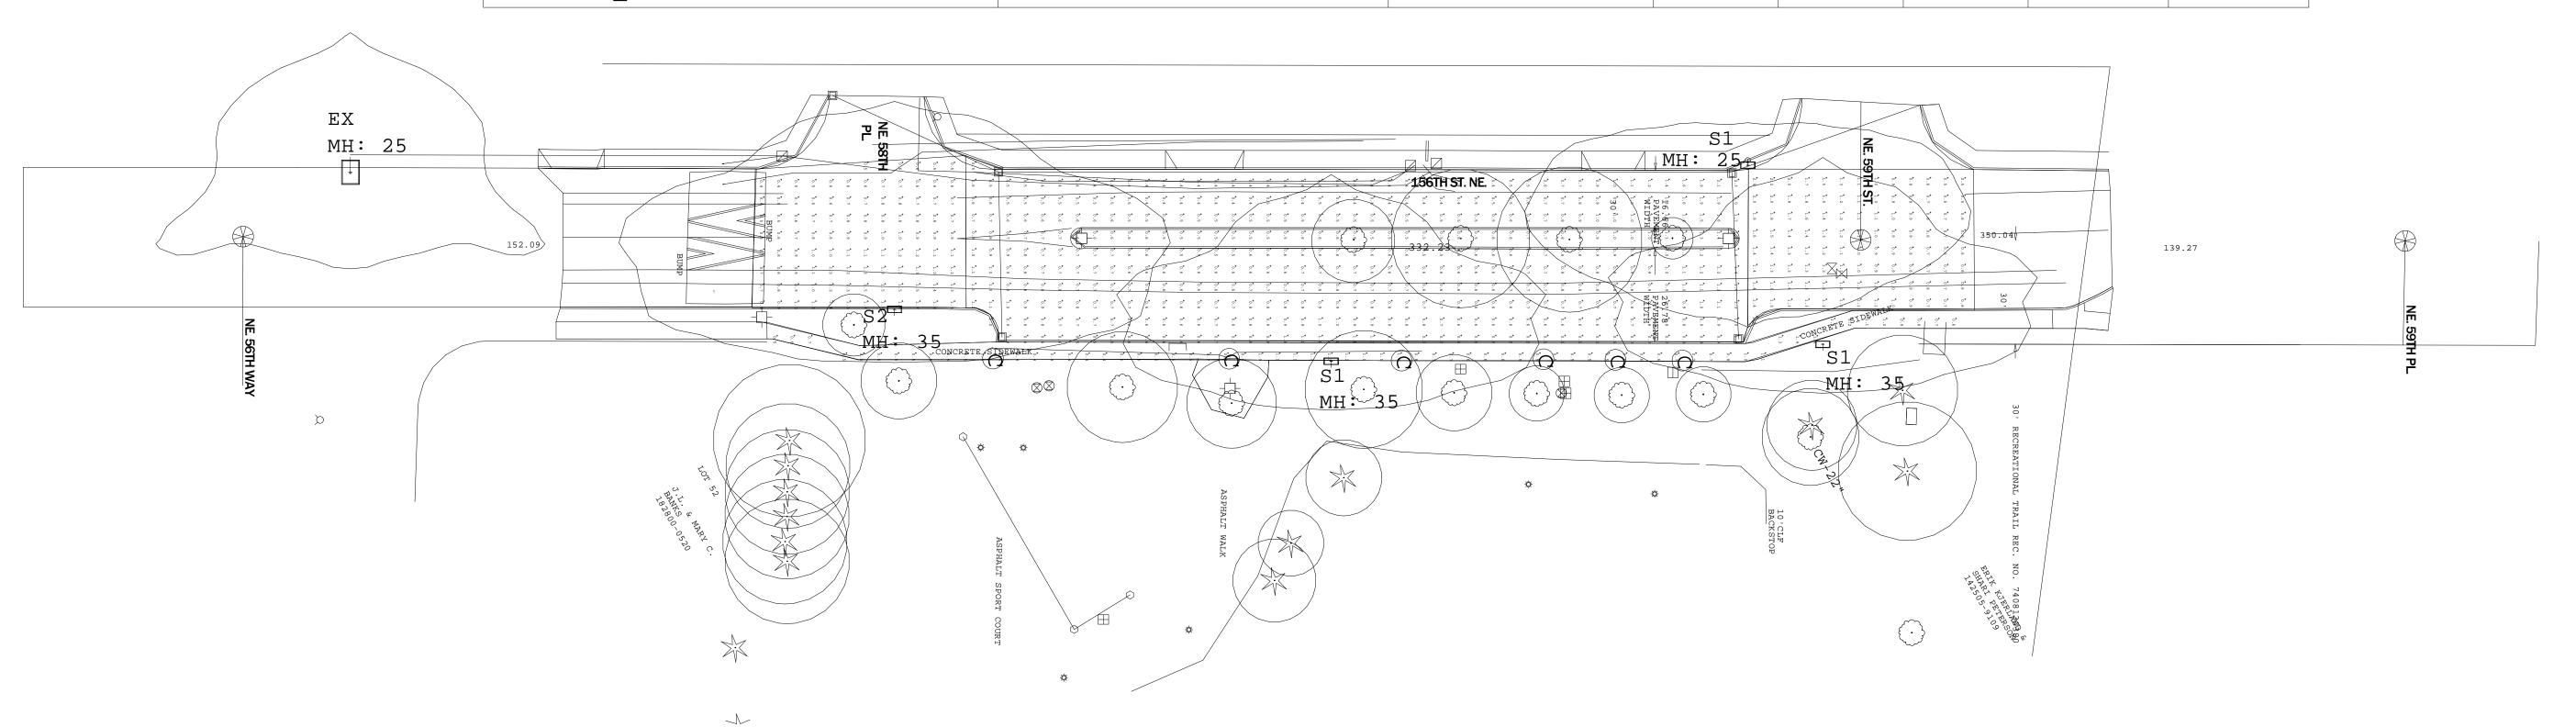

1 LIGHTING PHOTOMETRICS

1/16" = 1'-0"



Approved for Construction

Steve Flude, P.E. City Engineer DATE

THIS DEVELOPMENT SHALL BE CONSTRUCTED IN ACCORDANCE WITH THE 2020 CITY OF REDMOND STANDARD SPECIFICATIONS AND DETAILS.

MEP ENGINEER:
Edward Borden III, P.E.
4110 Tree Mist Ct.
Humble, TX 77346
832-541-8769
ebordeniii@gmail.com



REDMOND WESTSIDE
RENOVATION
5810 156TH AVE NE
REDMOND, WA 98052

OWNER: CITY OF

REVISIONS DATE DESCRIPTION

ISSUANCES

02.26.2020 30% PLANS 04.03.2020 60% PLANS

DATE DESCRIPTION

04.30.2020 SITE PLAN ENTITLEMENT

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ORIGINAL SHEET SIZE IS 22"x34"

BOARD & VELLUM PROJECT #: 2019176.00

PROJECT #: 500021924

PROJECT #: 500021924
PLOT DATE: 03/23/2020

SHEET: **E1.0**

LIGHTING PHOTOMETRICS

SHEET NO.: 35 OF 35